



हुगली कोचीन शिपयार्ड लिमिटेड  
(भारत सरकार का उद्यम)  
**HOOGHLY COCHIN SHIPYARD LIMITED**  
(A Govt. of India Enterprise)



वसुधैव कुटुम्बकम्  
ONE EARTH • ONE FAMILY • ONE FUTURE

Tender No: Hooghly-CSL/OPS/SB/TEN/2025/022,

Dated- 12.03.2025

### **NOTICE INVITING TENDER**

### **Piping Spools Fabrication, Testing, Onboard Installation & Commissioning of Piping Systems & Hydraulic System Piping for 40T BP ASD TUGS being constructed at Hooghly Cochin Shipyard Ltd, Nazirgunge unit, Howrah**

E-Sealed competitive tenders are invited on behalf of Hooghly Cochin Shipyard Limited (Hooghly-CSL) from experienced vendors for the under mentioned work, so as to reach the undersigned on or before the date and time mentioned below. Please refer Scope of Work, General Terms and Conditions and Special Terms attached.

<b>Tender No. &amp; date</b>	Hooghly-CSL/OPS/SB/TEN/2025/022, Dt.- 12.03.2025
<b>Scope of work</b>	Piping Spools Fabrication, Testing, Onboard Installation & Commissioning of Piping Systems & Hydraulic System Piping for 40T BP ASD Tugs being constructed at Hooghly Cochin Shipyard Ltd, Nazirgunge unit, Howrah (Detailed specification is enclosed separately)
<b>Type of Tender (LTE)</b>	Two Bid (E-mail mode)
<b>Cost of Tender</b>	Nil
<b>Earnest Money to be deposit</b>	Rs. 1,00,000/- (One Lac)
<b>Last date &amp; time of receipt of tender</b>	21.03.2025 at 1600 Hrs.
<b>Date &amp; time of opening of tender (Part – I)</b>	21.03.2025 at 1630 Hrs.
<b>Tenure of contract</b>	From the date of PO (or from the date of issuance of spool drawings / clearance from Project Manager). For Each Contractor, (i) Onboard pre-launch works, Onboard welding works; Onboard Piping spools Installation and commissioning to be completed within 30 days. (Yard Supplied Piping Spools) for one ship.



Registered Office: Administrative Building, HCSL Premises, Satyen Bose Road,  
P.O. Danesh Shaikh Lane, Nazirgunge, Howrah, West Bengal - 711 109.  
☎ +91 (33)-2688 8282 ✉ contact@hooghlycsl.com 🌐 www.hooghlycsl.com



Shipyard: Nazirgunge Unit, Satyen Bose Road, P.O. Danesh SK Lane,  
P.S. Sankrail, Howrah, West Bengal - 711109  
☎ +91 (33)-2955 8283



CIN : U35900WB2017GOI223197, GSTIN : 19AAECH3640L1ZD

	<p>(ii) Pipe Spools fabrication to be completed within 60 days (Yard supplied pipe and pipe fittings) for one ship. And Onboard pre-launch works, Onboard welding works; Onboard Piping spools Installation and commissioning to be completed within 90 days. (Using Pipe spools fabrication by contractor)</p> <p>(iii) Hydraulic Piping Works for each ship to be completed within 30 days of site clearance from Project Manager.</p> <p>(iv) Modification works (as / if required): For each ship to be completed within 30 days of site clearance from Project Manager.</p> <p><i>*Method of awarding work is as per Annexure 3 Para 2.</i></p>
<b>Officer - in – Charge (tender)</b>	<p><u>For Commercial:</u>  Name : Vijay Singh  Designation : Manager (SC&amp;C)  Email : <a href="mailto:vijay.singh@hooghlycsl.com">vijay.singh@hooghlycsl.com</a>  Phone No: : +918687069271</p> <p><u>For Technical:</u>  Name : Abhay Pratap Singh  Designation : Deputy Manager (Mechanical)  Email : <a href="mailto:abhay.pratap@cochinshipyard.in">abhay.pratap@cochinshipyard.in</a>  Phone No: : <a href="tel:+917994441148">+917994441148</a></p>

Tender to be submitted by E-mail only. No hard copy quotation of the bid will be accepted. Tender reference should be clearly indicated on the subject of the Mail. Tenders should be submitted in two separate files as PART-I "TECHNO-COMMERCIAL" & PART-II "PRICE" (Password Protected) indicating the *tender number, due date of the tender and subject as in-line with the scope of supplies* in the Mail addressed to: [vijay.singh@hooghlycsl.com](mailto:vijay.singh@hooghlycsl.com) / [abhay.pratap@cochinshipyard.in](mailto:abhay.pratap@cochinshipyard.in)

The tender documents can be downloaded from Hooghly-CSL/ CSL website <http://hooghlycsl.com/www.cochinshipyard.com>. The tender documents are available on above mentioned link. All corrigenda, addenda, amendments and clarifications to this tender will be hosted in the **website [www.cochinshipyard.com](http://www.cochinshipyard.com) or <http://www.eprocure.gov.in>** and not in the newspaper. Bidders shall keep themselves updated with all such developments till the last date and time of submission of tender.

**Tender administration:** Tender procedure/administration/evaluation including correspondences and awarding of contract will be done by M/s. Hooghly Cochin Shipyard Limited, Howrah, West Bengal.

  
**Vijay Singh**  
Manager (Subcontract & Commercial)  
Hooghly Cochin Shipyard Limited

**For Hooghly Cochin Shipyard Limited**

## TABLE OF CONTENTS

<b>Sl. No.</b>	<b>Description</b>	<b>Annexure</b>
1	Important Instruction To Bidders	Annexure-1
2	Technical Specification / Scope Of Work	Annexure-2
3	Terms & Conditions	Annexure-3
4	General Terms & Conditions	Annexure-4
5	Special Terms & Conditions	Annexure-5
6	Techno-Commercial Check List	Annexure-6
7	Price Bid Format	Annexure-7
8	List Of Deviation	Annexure-8
9	Vendor Details	Annexure-9
10	NEFT Mandate Form	Annexure-10
11	Form of Bank Guarantee towards EMD	Annexure-11
12	Format of bank guarantee towards SD	Annexure-12
13	Power of Attorney	Annexure-13
14	Form of Self-Declaration	Annexure-14
15	Form of Legal Cases	Annexure-15
16	Indicative Sample Spool Drawings	Annexure-16
17	Enclosures to Annexure 2	Enclosure 1 Enclosure 2 Enclosure 3 Enclosure 4 Enclosure 5 Enclosure 6

**For Hooghly Cochin Shipyard Limited**

**IMPORTANT INSTRUCTION TO BIDDERS**

**Minimum Qualification Criteria for Participating in The Tender Will Be as Follows:**

- 1.1. The Bidder shall be a single firm having experience in various Piping works, piping spools fabrication, onboard installation & commissioning of piping system in Shipbuilding / Shipyard / Marine application.
- 1.2. Experience as contractor in the successful completion or under execution of similar nature of work in preceding 3 years. (Work-order / Purchase Order / Work completion certificate from the Client for work done should be submitted along with bid). Vendor should have completed and submit the details of work experience in preceding 03 FY years (2021-22, 2022-23, 2023-24) of similar nature of works as:

**01 (One) work order of value at least Rs. 40 lakhs in past 3 FY's**

OR

**02 (Two) work orders of value at least Rs. 25 lakhs each in past 3 FY's**

OR

**03 (Three) work orders of value at least Rs. 20 lakhs each in past 3 FY's**

Similar nature means “The experience of successfully completed or under execution of similar works for piping fabrication, installation & commissioning of piping system in Shipbuilding / Shipyard / Marine application.

- 1.3. The Bidder should furnish the required work-specific information and satisfactory documentary evidence such as copy of work order / agreement, certificate from the employer for satisfactory completion of work along with the GST Invoice shall be submitted to Hooghly-CSL in support of its claim of experience.
- 1.4. The work experience shall comprise of work having comparable nature to that of fabrication, installation & commissioning of piping system. If the experience claimed by the bidder is of no relevance with respect to fabrication, installation & commissioning of piping system, then such experience will not be considered for pre-qualification. Decision taken by Hooghly-CSL in this regard will be final.

**Common Requirements from the Bidders:**

Following documents are required to be submitted by the bidders along with the Techno-commercial Bid (Part – I) submission:

- 1.5. The Bidder should enclose copy of statutory documents **PAN, GST registration certificate, Income tax returns for last three FY (2021-22, 2022-23, 2023-24) or of AY (2022-2023, 2023-2024, 2024-25).**
- 1.6. Audited Balance sheets showing turnover, Profit & Loss account of the firm for the preceding 03 years, FY (2020-21, 2021-22, 2022-23, 2023-24) should be submitted along with the

application for prequalification. **Net worth of the bidder must be positive as per the latest balance sheet. (MSE/NSIC may get exemptions as per prevailing Govt. norms).**

- 1.7. The average annual turnover of the bidder should be at least **Rs. 45 lakhs** during the last three preceding FY years (2021-22, 2022-23, 2023-24).
- 1.8. Bidder shall not be under a declaration of ineligibility issued by Govt. of India/ State govt./ Public Sector Undertakings etc. The bidder shall not have been debarred / black listed by CSL/Hooghly-CSL or by any of the Public Sector Undertaking or Government department etc.
- 1.9. Bidder performance on completed / ongoing works will be criteria for acceptance of offers submitted.

  
विजय सिंह  
Vijay Singh  
मैनेजर (अनु-संविदा एवं वाणिज्यिक)  
Manager (Subcontract & Commercial)  
होघली कोचीन शिपयार्ड लिमिटेड  
Hooghly Cochin Shipyard Limited

**For Hooghly Cochin Shipyard Limited**

**TECHNICAL SPECIFICATION / SCOPE OF WORK**

This tender enquiry pertains to the awarding of contract for Piping Spools Fabrication, Testing, Onboard Installation & Commissioning of Piping Systems & Hydraulic System Piping for 40T BP ASD Tugs.

Following is details of total scope of work:

Sl. No.	Description	No. of Ships
(i)	Pipe Spool Fabrication & galvanization etc from Yard supplied pipe and pipe fittings. (BOM at Enclosure 1)	02 Ships
(ii)	Pre-launch works & Testing, Onboard Installation & Commissioning from contractor fabricated spools.	02 Ships
(iii)	Pre-launch Works & Testing, Onboard Installation & Commissioning from Yard supplied spools.	02 Ships
(iv)	Hydraulic System Onboard installation, trials & Commissioning (P&IDs, BOM at Enclosure 4)	04 Ships
(v)	Modification works for Four Ships. (as, if required).	04 Ships
<i>*Method of awarding work is as per Annexure 3 Para 2.</i>		

**1. DESCRIPTION OF WORK**

1.1 The work includes Fabrication, Installation & Commissioning of piping system of the vessel(s) in accordance with the indicative specifications and drawings enclosed, delivery schedule, Hooghly-CSL - General Terms and Conditions in all respects.

1.2 Complete fabrication, testing, installation & commissioning of piping system, as per specifications and drawing.

1.3 Enclosures to Annexure 2 (Scope of Work) are as follows:

Enclosure 1: Material as per BOM of Pipe and fittings to be provided by yard for spool fabrication. (Qty. given is per ship). (Preliminary list)

Enclosure 2: BOM of Valves, fittings, to be installed onboard. (Qty. given is per ship). (Preliminary list)

Enclosure 3: Penetration List for onboard welding / Hot works (Preliminary)

Enclosure 4: BOM and P&IDs of Hydraulic tubes and Fittings. (Material supplied by yard)

1.3 Production drawings will be provided on commencement of work. The work is to be carried out at Hooghly Cochin Shipyard Ltd facility at Nazirgunge, Howrah.

1.4 Bidder are requested to obtain clarifications, if any, and carefully study the documents and the scope of work of Contractor and Hooghly-CSL, before submitting your offer.

1.5 The contractors are advised to familiarize themselves with the site conditions before quoting.

## **2. ABOUT THE VESSELS**

Main Particulars of the Vessels

Length Overall (Hull)	:	28.4 m approx.
Breadth (mld.)	:	11.8 m approx.
Mean Draught (mld.)	:	4.2 m approx.
Propulsion	:	Azimuth Stern Drive (ASD) (Twin)
Hull, Main Deck & Superstructure	:	Mild Steel IRS Gr. A

Flag: India

Classification: Indian Register of Shipping.

Class Notation:  $\nabla$  SUL  $\nabla$  IY TUG, INWATER SURVEY, AGNI1 (2400 m<sup>3</sup>/hour), ICV

## **1. MODEL OF CONTRACTING**

1.1. Hooghly Cochin Shipyard Ltd (Hooghly-CSL) proposes to offload fabrication, testing, installation & commissioning of piping system onboard for 40T BP ASD Tugs.

1.2. The work shall be carried out based on the contract specification, Piping drawing, Hooghly-CSL mentioned standards and Design drawings, up to the entire satisfaction of Hooghly-CSL / Owner / Class Surveyor, and up to the completion of satisfactory sea trials of the vessel.

1.3. Fabrication of spools is to be done inside Hooghly-CSL premises. If contractor intends to undertake spool fabrication in its shop / outside yard. The piping material will be issued to the contractor. The contractor need to submit Indemnity bond and the Insurance details, for the value of goods that will be lying at contractor premises.

## **3. SCOPE OF CONTRACTOR:**

### **(A) COMMON REQUIREMENTS**

3.1 Fasteners, Gaskets, and U Bolts shall be supplied and installed by the piping contractor only, as per piping system and marine standards. Basic specifications to be conveyed to yard for confirmation / acceptance and approval.

3.2 Welding machines, grinding machines, cutting machines and other equipment and tools required for the successful execution of work shall be positioned by the piping contractor only. All items / equipment's as required to be arranged by Piping contractor.

3.3 The Contractor shall arrange all, tools & tackles, surface treatment (galvanizing, pickling, painting, passivation) and all related consumables, items and equipment's required at his own responsibility and expenses.

3.4 Welding consumables (electrodes / CO2 Mig coils), Argon gas, Helium gas, grinding wheel, gaskets all required consumables and machines & tools are under the scope of the contractor.

3.5 Successful bidder shall procure/use Quality standard welding consumables for (TIG/Arc/Brazing/MIG) and certificates shall be submitted to Hooghly-CSL for verification. Welding of pipes is to be done by qualified welders by classification societies. (Welders with WPS certificates)

3.6 ICS (International Classification society) approved Welding electrodes will be in the piping work contractor scope.

3.7 Industrial LPG, CO2 gas any other required gases, Tig welding consumables, grinding wheel, gaskets all required consumables portable oven other machines & tools are under the scope of the contractor.

3.8 Flushing machine, Pressure testing pumps, pressure gauges for pressure testing, cutting tools, all consumables, production aids required for the work are under the scope of the subcontractor.

3.9 The work shall be undertaken by only qualified welders of the contractor. Towards this, Hooghly-CSL will provide the WPS and PQR. Welders will have to be qualified by Class IRS at Contractor's cost. The welder qualification will be carried out at Hooghly-CSL and the contractor would have to pay for the testing and certification charges.

3.10 Work will be undertaken and inspected as per the quality standards provided by Hooghly-CSL, and approved by Class and Owner of the vessels. The same may be seen prior bidding, if required. Copy of the standards will be provided while awarding contract.

3.11 All welding machines are to be calibrated.

3.12 The Bidder shall have sufficient TIG welding machine with pressure regulators for Argon gas, Helium Gas with flow meter.

3.13 Lifting tackles like Chain Pulley (up to 10 Ton), Lifting Belt, Wire rope and D Shackles / Bow Shackles is in contractor scope.

3.14 Housekeeping work at respective work areas.

3.15 Pressure Testing arrangement is in contractor scope as well as need to show the pressure test in front of Hooghly-CSL QC and Class surveyor.

## **(B) FABRICATION OF PIPE SPOOLS**

3.16 The Contractor shall execute the work as per the specifications / drawings issued and to the satisfaction of Hooghly-CSL.

3.17 Pipe spool fabrication – as per BOM and spool drawings provided per vessel. The BOM provided is for preliminary estimation/quantum of work. Actual works to be as per spool drawings to be issued by yard with PO.

3.18 Detailed piping and fittings Bill of Material (BOM) is as per Annexure 2 Enclosures. Complete pipe spools fabrication for two ships.



3.19 Under subject scope, following are for 04 ships, (included in BOM), Below 32DN (i.e. 25 and below) and above 300DN (300DN and above) and IRS Class pipes (for sea-chest and OBDs).

3.20 The contractor shall be responsible to Hooghly-CSL for the following: -

(a) Fabrication of the pipe spools as per drawing and piping standard as indicated by Hooghly-CSL. Sample spool drawings attached for references.

(b) Fabrication scope includes Cutting, Bending, Edge preparation of the pipe spools, Fit up survey, Full Welding, Dry survey, galvanizing (for CS items) and shop floor testing.

(c) Pipe will be fabricated as per specification and the drawing provided by Hooghly-CSL. The reference sample drawing is enclosed at Annexure 16.

(d) Collection of material, material movement & accounting of the items.

(e) All pipes root should be in TIG welding and balance (cover/ filling runs) Arc / Mig (CO<sub>2</sub>) welding for carbon steel pipes. Proper root penetration to be ensured (will be thoroughly checked during Quality Checks).

(f) All Stainless Steel (SS) pipes to be only TIG welded.

(g) The spools should be pressure tested for any leakages and, if found any defect, same should be rectified by contractor. Making good of any defects due to workmanship of contractor has to be undertaken by contractor at no extra cost.

(h) Pipes which require Hot-Dip Galvanizing shall be done with sand/grit blasting/special cleaning/ pickling with approved chemicals etc. to remove oil, grease, paints, varnish, rust etc. to make the surface ready for Hot-Dip galvanizing and then galvanizing (85-120 microns).

(i) All welding works shall be carried out by approved and qualified welders only.

(j) Welding spatters and slags on the flange face shall be removed.

(k) No holes other than those existing in the units are to be drilled to ease slinging while galvanizing. However, suitable hooks may be welded for slinging while galvanizing and removed later after galvanizing, at no extra cost. Any damage to the material while welding hooks or otherwise while in the premises of galvanizer should be rectified/replaced compensated by the bidder.

(l) Cleaning of materials after galvanizing and removing lump of zinc sticking to the surface (both inside and outside), if any. Galvanization of 85-120 microns need to be ensured and will be thoroughly inspected. Also, no zinc spray should be used.

(m) Galvanization including pickling of spools: Taking from yard, pickling & galvanization of spools and return of material to yard is in contractor scope. Including insurance.

(n) Pipes in which pickling is required, shall require blasting prior going to pickling and coat of Primer(spray)/paint(spray) coating of marine grade primer (50micron) to be done.

- (o) Stainless steel pipe to be passivized.
- (p) Pickling/ galvanizing/Passivation to be done as per the details given in fabrication drawing/yard standard.
- (q) Punching of pipes with MLF, paint code, Pipe spool numbers and Ship number as indicated by Hooghly-CSL in the drawings.
- (r) As per Hooghly-CSL piping practice all pipes will having inspection by Hooghly-CSL QC/OWNER, any imperfection/rejection/deficiency to be rectified by the contractor without any additional charges.

3.21 Contractor shall maintain quality as per Hooghly-CSL quality standards and yard quality procedures. Hooghly-CSL will conduct inspection during fabrication.

3.22 Entire work as per Work order must be completed within the time line as per Hooghly-CSL load conditions.

3.23 Bidder should be ready to work round the clock and multiple shifts as per requirement.

3.24 All works shall be as per strict compliance to approved Hooghly-CSL drawings/material type/ QAP.

3.25 All works to be as per standard industrial practices, marine applications and piping fabrication works standards.

### **(C) ONBOARD FITMENT AND TESTING OF PIPE SPOOLS & TUBES WITH SUPPORT**

Preliminary Technical details (for each ship):

- Number of pipes - Approx. 1500 nos.
- Total Length of pipes – 2500 m approx.
- Number of valves – 326 nos. approx.
- Various systems in vessel are as follows:-
  - (i) Exhaust System
  - (ii) FO System
  - (iii) LO System
  - (iv) Machinery cooling System
  - (v) Compressed air System
  - (vi) External Fire Fighting System
  - (vii) Bilge and fire System
  - (viii) Filling, Air vent, Sounding & Overflow System
  - (ix) Sludge & Oily water System
  - (x) Technical water System
  - (xi) Black & Grey System

- (xii) Potable water System
- (xiii) Scupper & Drain System
- (xiv) Oil Dispersant System
- (xv) Hydraulic System
- (xvi) CO2 System

3.26 Installation scope includes pipe & support installation onboard and presenting dry survey. Including fitment of valves.

3.27 Commissioning scope involves testing of pipe lines, commissioning assistance till completion of the vessel.

**3.28 Flushing of the fuel & hydraulic pipe lines. Flushing machine to be arranged by contractor. For systems like, FO / LO / Hydraulics & Compressed air etc. Any consumable required for flushing including oil and sample testing of oil is in vendor scope.**

3.29 Testing scope includes blanking of pipes and pressuring with required medium and offering surveys to the Hooghly-CSL QC, Owner and Class.

3.30 The job includes collection of pipes from Stores/contractors skid, transportation to the ship/blocks and fitment onboard the ship as per the MLF, Yard plan and Revision drawings if applicable, and procurement of material for pipe supports as well as the pipe spools with Nominal Bore less than 32 mm as per key plan, schematic drawings and Hooghly-CSL quality standards etc.

3.31 Pipe spools with Nominal Bore less than 32 mm has to be routed and fitted as per the site condition, no spool drawings for the same will be provided by the yard.

3.32 Bidder should have sufficient experience in fitment of hydraulic precision tubes and same to be submitted along with the offer.

3.33 All fitment and welding job are under the scope of Outfitting contractors.

3.34 Jobs including outfitting of all the bulkhead penetrations, brackets, supports, doubler pads, erosion pads, striking pads, coupling, scuppers, gauges, strainers, flow-meters, level gauges/ sight glasses, bellows, etc.

3.35 Also, all the foundations and seats if any for the above will be done by the respective contractors, which includes alignment, marking, fitment and welding.

3.36 The job includes leak / hose testing of overboard valves/pipes, fixing of valves and supports, blanking of valves, scupper, removing and refitting of pipes, if required for other works etc.

3.37 All the accessories like bolts & nuts, clamps, gaskets, U clamps and any components required for completion of pipe/ structural outfitting will be scope of

contractor as per MLF. Fasteners, Gaskets, U bolts etc. for onboard installation are included in the contractor scope of supply.

3.38 Fitment and welding of accessories like bosses/ square flange for fixing the instruments/gauges will be under the scope of the contractor.

3.39 Precision tubes laying, fitment and bending as per yard plan and Hooghly-CSL BOM are under the scope of contractor.

3.40 **The layout of piping system including making pipe system withstand 1.5 times system working pressure and then offering to QC and subsequently to OWNER & CLASS to their best satisfaction.** Any comments arising during the layout to be liquidated immediately. If there is delay in mitigation of comments, the pressure testing will be done by Hooghly-CSL and rectification delay will be accounted against the particular contractor.

3.41 Work has to be executed as per the instructions from executing officer and detailed plan of execution to be shared within a week of purchase order received by vendor.

3.42 Contractor shall ensure all pipe supports fabricated are painted before fitment onboard the ship otherwise it has to be handed over to Hooghly-CSL for painting.

3.43 The outfit survey of tanks to be presented to the QC and subsequently to OWNER & CLASS after completing all piping related jobs including mopping the debris and dewatering if any. The tank needs to be presented for box up survey after completing all the works and same needs to be closed. The gasket, bolt and nut will be scope of contractor.

3.44 Installation and fitment of all closing pieces to machineries including flexible hoses and bellows are within the scope of the contract.

3.45 All template pipes will be supplied by Hooghly-CSL in tack welded condition which needs to be welded onboard as per site condition. Pipes with flanges/ sleeves in tack-weld condition needs to be welded onboard as per site condition.

3.46 Total pipe includes the template pipes, precision tubes, MS pipes, SS and PVC pipes etc.

3.47 Fixing name plates by riveting on valves and equipment as per the schematic plan (P & I drawing).

3.48 The scope includes assistance for flushing of hydraulic systems, lube oil system and fuel oil system. The necessary looping for flushing and pressure testing to be

performed by the executing contractors.

3.49 Removal and refit of pipes for hull works, equipment erection, commissioning activities etc. to be done without extra cost.

3.50 There may expected 5% modification in the pipe fitment due to pipe fouling with hull, incorrect fabrication in the shop, Additional revisions in the drawing (other than the attached revisions), fouling with the other machineries, and additional pipes by revision etc. Same has to be envisaged and included in current offer.

3.51 Material movement & accounting of the items are in the scope of work of contractor.

3.52 All tools and tackles required for the work are under the scope of the sub-contractor and needs to comply with the safety rules and regulation of Hooghly-CSL. Minor staging up to 3m height shall be erected by the contractor for the work using Hooghly-CSL material without any separate payment. Any requirement over and above this shall be arranged by Hooghly-CSL separately.

3.53 Each contractor should have a good coordination with his counterpart in the same vessel during the collection of materials from shops/ stores /contractor skids.

3.54 Survey presentation to Yard I&QC, Client and Class authorities as per yard practices and standards. Documents for the same may be accessed at Hooghly-CSL. Copies of the same will be provided at the time of awarding contract.

3.55 Rectification of defects as per the comments from Yard I&QC, Client & Class authorities.

3.56 Arranging supporting blocks, jigs fixtures etc. for fabrication shall be to subcontractor scope.

3.57 Mobilization of entire labor / Workmanship (Skilled/ Semiskilled / Unskilled) required for the subject scope of work,

3.58 The job includes drilling of holes with reference to all piping works and pipe clamps fixing,

3.59 Provision of required PPE and safety appliances to workmen,

3.60 Fabrication, fitment and testing of all piping systems as per the General Arrangement plan and piping drawings.

3.61 Equipment end connection under the scope of the contractor.

3.62 Testing of piping systems as per Class requirement.

3.63 Supply & fixing of all "U" clamp for pipe support with necessary nut, washers, gaskets, rubber sheet are in contractor scope as per required sizes

3.64 The entire Deck/ BHD Penetrations and Over-board pipe fit-up and welding on hull will be done by the respective piping contractor.

3.65 For pipe installation all gaskets under contractor scope.

3.66 Removal and refit of pipes if required.

3.67 Hot dipped galvanization of CS pipes is in contractor scope.

3.68 The last spool shall be kept loose to adjust at site to prevent mismatch and onsite fouling issues. Drawings to be matched with onboard measurements.

3.69 Bilge Eductor, all end connections, installation of flexible hoses / bellows etc piping connection to equipment's is in contractor's scope.

**3.70 Leak rectification during onboard testing is in contractor's scope at no additional cost.**

3.71 CO2 system copper / SS tubing work is in contractor scope.

#### **4. OTHER CONDITIONS:**

4.1 The contractor shall depute qualified piping engineer and welders and fitters with experience in pipe fabrication / ship pipe repairs or piping on floating marine structures.

4.2 The contractor shall have sufficient TIG welding machine with pressure regulators for Argon gas, Helium Gas with flow meter.

4.3 The contractor shall have sufficient mechanical cutting tools for cutting MS / stainless steel pipes. List of portable tools used for piping works to be submitted after placement of work order.

#### **5. INSPECTION / TESTING/ QA AND QC**

5.1 Vendor to submit Quality assurance plan (QAP) and welding procedure specification (WPS) for vetting by QC Hooghly-CSL. Qualified welders to be engaged.

5.2 The complete work has to be carried out under the survey of Hooghly-CSL Quality Control Dept. Pressure testing at 1.5 times of system pressure.

5.3 Contractor to maintain the required dimensional accuracy and surface finish as per quality standards.

5.4 Contractor to maintain the required dimensional accuracy and surface finish as per quality standards provided by Hooghly-CSL

5.5 All test and Inspections shall be carried out as per approved QAP.

5.6 All works shall be as per strict compliance to weight control and approved Hooghly-CSL drawings.

5.7 Contractor to maintain the required dimensional accuracy and surface finish as per quality standards provided by Hooghly-CSL.

### **(D) HYDRAULIC SYSTEM:**

Complete onboard installation, trials and commissioning. BOM placed at Enclosure 4 to Annexure 2. Pressure testing at 1.5 Times of system pressure.

#### **1. CLASS COMPLIANCE, TESTING AND INSPECTION**

- After installation and commissioning, on board tests/trials shall be carried out as per Hooghly-CSL/OEM standard practice and to the satisfaction of Classification societies / other statutory requirements.
- Any faults found at this stage, shall be corrected to the satisfaction of all related parties before the delivery of the ship without additional cost.
- Sea trials shall be undertaken as per the class and manufactures standard.
- All certificates required by the Class; Rules & Regulation shall be provided

#### **2. TECHNICAL SPECIFICATION**

##### **Scope of work:**

##### **A. Contractor Scope**

1. Fabrication and installation of pipe line as per respective P&ID & BOM (Yard Supply).
2. Inter connection line between hydraulic power pack. Fitment of flexible hydraulic hoses with fittings is in vendor scope. Supply of flexible hoses is in yard scope.
3. Pressure test of the hydraulic tubing shall be in contractor scope. Necessary arrangement for pressure testing including consumable and necessary calibration certificate is in contractor scope. All hydraulic tubing shall be hydrostatic tested to 1.5 times the relief pressure.
4. All hydraulic tubing shall be flushed properly before installation and commissioning of the system.
5. Fitment and welding of BHD fittings or deck fittings is in vendor scope
6. Manpower assistance during basin trial and sea trial
7. Contractor shall carry out the complete work in accordance with drawings provided by shipyard. Any minor modifications from drawing or any other work or supply of material, which is not specified hereunder, but is considered incidental and essential for the successful completion of the job shall be carried out by the contractor without any additional charge.

##### **LIST OF DRAWINGS**

- a. General Arrangement

- b. Schematic
- c. Diagram of Electro Hydraulic Steering Gear System

## 6. **INSPECTION**

- 6.1. Work will be undertaken and inspected as per the quality standards provided by Hooghly-CSL, and approved by CLASS and Owner of the vessels.
- 6.2. The complete work has to be carried out under the survey of Hooghly-CSL, CLASS and Owners. The works are to be inspected and approved by Hooghly-CSL initially and thereafter presented to CLASS and the Ship Owner for their survey and approval.
- 6.3. After installation the system piping has to be tested as per IRS Class rules.

## 7. **SCOPE OF HOOGHLY-CSL:**

- 7.1. Preliminary BOM and spool drawings for respective systems. Supply of drawings & materials, equipment in the list of piping's for Piping works for the mentioned scope of work. Supply of drawings, for the mentioned scope of work.
- 7.2. Pipe and Pipe fittings material for two ships for spool fabrication will be provided by yard and Fabricated Pipe spools for two ships will be provided by yard for onboard installation.
- 7.3. Valves and fittings for onboard installation.
- 7.4. Required angle / Flat bar for clamp support will be provided by yard.
- 7.5. Assistance from yard will be limited to Entry pass for personnel /Crane assistance/Fork Lift assistance for loading and unloading of items within Hooghly-CSL premises, subject to availability at free of cost.
- 7.6. Hooghly-CSL shall not be responsible for any compensation to personnel for injuries etc. damage to vehicles involved in accidents under any circumstance, whatsoever.
- 7.7. Quality Assurance Plan (QAP) and applicable Welding Procedure Specification (WPS) will be provided.
- 7.8. Providing Electricity, Water, compressed air (at available pressure).
- 7.9. Services of Hooghly-CSL cranes and forklifts, subject to availability.
- 7.10. Required space for storage of materials inside the Yard (if required)
- 7.11. Staging / scaffolding above 3M height (as per requirement)
- 7.12. Place for work, Power Supply, Drinking Water, Crane & MHE Support
- 7.13. Space for positioning of contractor's office container if any. Power and water supply will be provided to the container, within the yard premises.



**TERMS & CONDITIONS**

1. Piping Spools Fabrication, Testing, Onboard Installation & Commissioning of Piping Systems & Hydraulic System Piping for 40T BP ASD Tugs being constructed at Hooghly Cochin Shipyard Limited, Nazirgunge Unit, Howrah.

**2. METHOD OF AWARDING CONTRACT**

2.1. Contract will be concluded with bidder qualifying technically (including eligibility criteria), agreeing to commercial conditions and emerging as L1 as per Annexure- 7 (Price Bid) of this tender document.

2.2. 'For One ship pipe spool fabrication and for two ships onboard installation works, and modifications and Hydraulic piping' will be awarded to L1 bidder, and 'for one ship spool fabrication and for two ships onboard installation works, and modifications and Hydraulic piping', will be awarded to the next inline bidder who matches the prices quoted by L1 bidder.

2.3. Out of Piping works as required to be completed under current scope of work. Order will be placed on maximum 2 bidders, when they will match L1 bidder rate. Details given below:

Sl. No.	Description	Work Scope for No. of Ships	Qualified L1 bidder	Next inline qualified bidder upon matching of L1 price
(i)	Spool Fabrication & Galvanization etc. from Yard supplied pipe and pipe fittings.	Two Ships	One Ship	One Ship
(ii)	Onboard pre-launch works, welding works; and Onboard Piping spools Installation and commissioning from contractor fabricated spools.	Two Ships	One Ship	One Ship
(iii)	Onboard pre-launch works, welding works; and Onboard Piping spools Installation and commissioning from Yard supplied spools.	Two Ships	One Ship	One Ship
(iv)	Modification works for Four Ships. (as, if required).	Four Ships	02 Ships	02 Ships
(v)	Hydraulic System installation and commissioning (Yard supplied Material)	Four Ships	02 Ships	02 hips

2.3 If none of the alternate bidders matches the L1 price, **then 100% of the tendered Quantity will be awarded to L1 bidder.**

2.4. If none of the alternate bidders matches the L1 price, Hooghly-CSL reserves the right to split the work / percentage of work to any number of bidders upon matching of L1 price or to cancel the tender if required.

2.5. If any contractor, to whom the work is awarded, is not performing as per Hooghly-CSL work plan, Hooghly-CSL officer in charge has the right to modify / cancel the scope of work or volume of work in WO/PO and allocate to another contractor/bidder as required. Hooghly-CSL reserves the right to split the work / percentage of work to any number of bidders (up to H1) upon matching of L1 price.

### 3. **PLACE OF WORK**

Hooghly Cochin Shipyard Limited  
131/1, Satyen Bose Rd, Nazirganj,  
Guabaria, Mourigram, Howrah- 711109, India.

### 4. **WORK PLAN / WORK COMPLETION SCHEDULE**

4.1. From the date of PO (or from the date of issuance of spool drawings / clearance from Project Manager). For Each Contractor,

- For First ship, Spool fabrication to be completed within 60 days of PO (Yard supplied pipe and pipe fittings). And, Onboard Pre-launch works & Testing, flushing, Onboard welding works, Onboard Piping spools Installation and commissioning to be completed within 90 days of PO. Using Pipe spools done by contractor.
- For First Ship, Onboard Pre-launch works & Testing, flushing, Onboard welding works, Onboard Piping spools Installation and commissioning to be completed within 30 days of PO. (Yard Supplied Piping Spools).
- Hydraulics System Piping: For each ship within 30 days, upon site clearance by Project Manager.
- Modification Works: For each ship within 30 days, upon site clearance by Project Manager.

4.2. If required, work on each vessel is to progress simultaneously.

4.3. Associated Material positioning in scope of contractor, has to ensure that it should not withhold production.

4.4. The contractor shall submit their detailed scheduled of completion of the work, in consultation with the officer in-charge. The progress of work shall be made in tandem with the progress of completion of the vessel allowing sufficient time for other interface activities / works.

4.5. Yard has the right to change the schedules of the project in the interests of the company and the firm should be capable of adjusting the resources according to the instructions from the yard contact person.

4.6. Progress of work to be updated to officer in charge in requested format (MS Project /MS Excel/ MS Word) every Monday/ as and when a review meeting is called for.

**5. VALIDITY OF OFFER**

The offer shall be valid for acceptance for a period of 90 days from the date of opening of the Part-I Techno-Commercial Bid.

**6. VALIDITY OF CONTRACT**

Once the contract is awarded, the price offered and mutually agreed shall remain firm till **completion of work** and no escalation in labour, transportation cost etc. shall be allowed by Hooghly-CSL on whatsoever reason thereafter.

**7. PAYMENT TERMS**

7.1. Payment will be made for respective / each line item and for each vessel separately. Payment will be made as per below details. Payment will be as per actual measurement basis. Proper documents to be submitted for billing and certification.

Sl. No.	Description (Work Scope)	Payment milestones (Payment will be made against each line item separately as per Contract value of respective line item in PO). "And Stage wise payment against each line item will be based on %age of Contract value against respective line item in PO"
(i)	Spool Fabrication from Yard supplied pipe and pipe fittings.	<ul style="list-style-type: none"> <li>➤ Payment will be per ship value of respective works (of Contract value of respective line item in PO)</li> <li>➤ For ship for which complete piping work fabrication &amp; installation is in contractor scope:               <ul style="list-style-type: none"> <li>• 60 % on completion of spools fabrication.</li> <li>• 20 % on Completion of onboard installation, testing and commissioning works &amp; liquidation of observed defects.</li> <li>• 20% on completion of final commissioning and trials and liquidation of observed defects.</li> </ul> </li> </ul>
(ii)	Pre-launch works & Testing, Onboard Installation & Commissioning from contractor fabricated	<ul style="list-style-type: none"> <li>➤ Of per ship value of Contract value of respective line item in PO (For ship for which only onboard installation related works are in contractor scope):               <ul style="list-style-type: none"> <li>• 20% on completion of pre-launch works.</li> <li>• 60 % on completion of erection of piping</li> </ul> </li> </ul>

	spools.	<p>systems.</p> <ul style="list-style-type: none"> <li>• 20 % on completion of final installation, testing, commissioning works and trials and liquidation of observed defects.</li> </ul>
(iii)	Pre-launch Works & Testing, Onboard Installation & Commissioning from Yard supplied spools.	<ul style="list-style-type: none"> <li>➤ Of per ship value of Contract value of respective line item in PO</li> </ul> <p>(For ship for which complete only installation works are in contractor scope):</p> <ul style="list-style-type: none"> <li>• 20% on completion of pre-launch works.</li> <li>• 60 % on completion of erection of piping systems.</li> <li>• 20 % on completion of final installation, testing, commissioning works and trials and liquidation of observed defects.</li> </ul>
(iv)	Hydraulic System Installation and commissioning	<ul style="list-style-type: none"> <li>➤ Of per ship value of Contract value of respective line item in PO.</li> <li>➤ For each ship. <ul style="list-style-type: none"> <li>• 50% on completion of Fabrication of spools and Pressure testing and flushing, to the satisfaction of Hooghly-CSL representative, Classification society and the owner's representative as applicable.</li> <li>• 30% on completion of Erection, installation, commissioning and completion of scope of work, to the satisfaction of Hooghly-CSL representative, Classification society and the owner's representative as applicable.</li> <li>• 20 % on completion of final installation, testing, commissioning works and trials and liquidation of observed defects.</li> </ul> </li> </ul>
(v)	Modification works for Four Ships. (as, if required).	<ul style="list-style-type: none"> <li>➤ Of per ship value for each line item (Limited to max. 20% of per ship value). Payment will be as per actual measurement for respective works / at actuals. (Of Contract value of respective line item in PO)</li> <li>➤ For each ship. <ul style="list-style-type: none"> <li>▪ 80 % on work completion certification</li> <li>▪ 20 % on completion of final installation, testing, commissioning works and trials and liquidation of observed defects.</li> </ul> </li> </ul>

7.1.1. Payment shall be made on the basis of certification by Hooghly-CSL officer in-charge. Contractor shall submit work completion certificate issued by Hooghly-CSL authority. Upon certification of work to the satisfaction of Hooghly-CSL representative, Classification society and the owner's representative as applicable.

7.1.2. The payment will be made within 30 days from submission of invoice along with the work completion certificate.

7.1.3. All claims for payment for the work/ additional work (if any as per special instruction from OIC) shall be submitted by the contractor within one month of completion of work.

7.1.4. Payment will be made by RTGS / NEFT to the account of agency. The name of the bank, branch, A/C No., IFSC code & other particulars shall be furnished by the agency in the proforma of Hooghly-CSL.

7.1.5. Above % payment of order value with applicable taxes will be released against original invoice subject to the full satisfaction and acceptance of work / items by Officer - In-Charge. Original tax invoice should contain GST number of both parties and submit in triplicate.

7.1.6. Contractor shall indicate details such as PAN, GST required for processing payment. Hooghly-CSL reserves the right for the deduction of taxes and duties as applicable from the bill or invoice.

7.1.7. In case milestone for stage payment is not achieved, for reasons not attributable to contractor / site clearance not issued by Hooghly-CSL, payment can be considered on case to case basis, at Hooghly-CSL discretion, based on actual measurement basis (for completed work, certified by execution department of Hooghly-CSL).

## **8. ADDITIONAL WORKS**

8.1. Any additional works up to 05% growth of work on the material and spool fabrication in terms of total quantity of material and spools is to be envisaged and is to be undertaken without any additional price impact.

8.2. In case of additional work (minor rework/modification), written consent is to be obtained from the Officer-in-charge before commencement of the work.

8.3. Contractor shall carry out the complete work in accordance with Shipyard's approved drawings. Any minor modifications from drawing or any other work or supply of material, which is not specified hereunder, but is considered incidental and essential for the successful completion of the job shall be carried out by the Contractor without any additional charge.

8.4. The contractor shall be responsible for any damage caused to the spools supplied to Hooghly-CSL. Compensation with penalty for damage or loss of the item will be recovered from the Contractor, in the event of loss or damage.

## 9. GROWTH OF WORK

Hooghly-CSL shall be at liberty to place additional work to the extent of contract value at the same rate, terms and conditions of the contract within contractual period and bidder shall have to honor it. Such additional work shall be entrusted to the contractor through a separate Order to that effect or through an amendment to the Order. In any case, the contractor should not undertake any (additional) work beyond the Contractual period without prior intimation by the Officer in charge. This additional work is considered beyond the total order quantity.

## 10. GUARANTEE FOR THE MATERIAL TAKEN OUT FROM Hooghly-CSL

The successful bidder should furnish Indemnity Bond i.e **15% of total material cost for material taken out from Hooghly-CSL (for galvanization etc) in the approved format of Hooghly-CSL** (Annexure-15)

“All risk Insurance cover for "Material lying down at contractor premises during the work/till dispatch shall be covered under the scope of the piping Contractor only. The approximate cost of material to be insured will be intimated at the time of dispatch for outward.” However, Transit insurance to and fro shall be borne by Hooghly-CSL.

## 11. TAXES & DUTIES

GST shall be applicable extra on the prescribed work. Bidders are requested to furnish the following details in the invoice/Bill.

- Applicable rate of GST/SAC Code
- Firms GST Reg. NO.
- Service accounting code (SAC) as prescribed by statutory authorities
- GST Registration Number of Hooghly Cochin Shipyard Limited is **19AAECH3640L1ZD**

## 12. MSE/ NSIC BENEFITS (If and only if the certificate issued is in the relevant field)

**A.** The following benefits are extended for all the firms who are registered with district industries center and come under the category of **Micro and Small Enterprises** holding a valid Entrepreneurs Memorandum (EM) Part ii certificate or Udyog Aadhaar Certificate. However, in order to avail the benefits as per public procurement policy for MSE's orders, 2012, all MSE bidders are required to declare their Udyog Aadhaar Memorandum (UAM) number in Central Public Procurement Portal (CPPP) compulsorily.

- Tender Forms Shall Be Issued Free of Cost.
  - Payment of earnest money deposit (EMD) is exempted.

**B.** For all firms who are registered with National Small Industries Corporation (NSIC) and come under Micro and Small Enterprises holding a valid NSIC certificate, the below benefit also extended in addition to above.

Waiver of security deposit (SD) for the performance of the contract (5% of the order value by the way of bank guarantee till the supplies are completed), up to financial limit as mentioned in NSIC certificate.

C. This tender shall be based on MSE order dated 23<sup>rd</sup> march 2012, pertaining to public procurement policy.

D. MSE's quoting price band L1 + 15% (in the ascending order) may be awarded complete work, considering spirit of policy for enhancing the government procurement from MSE's.

E. Traders are exempted from the benefits from Public Procurement Policy, for MSEs Order, 2012. As mentioned in O.M. No. 5/2(2)/2021-E/P & G/Policy dated 02.07.2021, Retail and Wholesale traders can register on Udyam Registration Portal for the purpose of Priority Sector Lending (PSL) only.

13. **COST OF TENDER AND EMD (EARNEST MONEY DEPOSIT)**

a) Cost of Tender: Nil

b) Tenderers shall deposit an amount of **Rs. 1,00,000 (Rupees One Lac)** as Earnest Money Deposit (EMD) along with the tender.

c) The EMD can be remitted in the form of Demand Draft (DD) / Banker's Cheque / Fixed Deposit Receipt (FDR)/ Bank Guarantee drawn in favor of 'Hooghly Cochin Shipyard Ltd. payable at Kolkata and shall be valid for a period of 6 (Six) months from the due date of opening of Techno-commercial Bids from any Nationalized/ Scheduled Bank or paid online through e-gateway of -

**HOOGHLY COCHIN SHIPYARD LIMITED  
STATE BANK OF INDIA  
COCHIN SHIPYARD BRANCH  
ACCOUNT NO: 37354232301  
IFSC CODE: SBIN0003229**

d) EMD of bidders (unsuccessful during first stage i.e. technical evaluation etc.) shall be returned after declaration of result of first stage i.e. technical evaluation.

e) EMD of bidders (unsuccessful after price bid opening) will be released after issuance of work order and its acceptance by the contractor to whom the work is awarded.

f) EMD of the successful bidder will be refunded after remittance of the security deposit.

g) EMD deposited with the Client will be forfeited,

(i) if a bidder withdraws or modifies his bid during the period of validity specified or

(ii) if the successful bidder fails within the time limit to sign the agreement document or fails to furnish the required security deposit.

(iii) Request for enhancement in the quoted rates or bringing in new conditions after tender opening or unnecessary delayed acceptance of the order / commencement of work / submission of Security Deposit.

h) The relevant documents pertaining to the EMD should be enclosed with Techno-commercial Bid. Tenders Received Without EMD Will Not Be Considered For Further Evaluation.

14. **SECURITY DEPOSIT/WARRANTY BANK GUARANTEE**

The successful tenderer shall remit 5% of the value of the contract as security deposit within 07 days of receipt of the work order. This amount may be remitted by way of

demand draft or bank guarantee (in approved proforma of Hooghly-CSL) from any of the scheduled banks, valid till the satisfactory completion of the entire work i.e. receipt of material / spools at yard. The Security Deposit will be released after satisfactory completion of the contract i.e. receipt of material / spools at yard and on certification of nil liability to Hooghly-CSL by Officer-in charge. Submission of Performance Security is not necessary for a contract value up to Rupees 20 (twenty) lakh.

15. **LIQUIDATED DAMAGES**

In case of delay in supply of ordered materials or execution of work beyond the stipulated completion period, which is not attributable to Hooghly-CSL, supplier is to pay Liquidated Damages (and not by way of penalty) a sum equivalent to ½% (half percent) per week or part of the week of the total basic price of the contract value subject to a maximum of 10% of the total basic price of the contract value / undelivered value (Total basic price is the order value excluding freight, taxes, other charges etc.). Further GST will be applicable upon LD and the same also will be deducted along with LD. However, LD applicability is without prejudice to Hooghly-CSL right to terminate contract for delayed delivery or other actions as per Risk Purchase clause.

16. **RISK PURCHASE**

If the contractor fails to commence the work in time, as per the terms in work order or violate any other terms & conditions of work order OR If the firm's performance is found not satisfactory with regard to the progress of work, quality, and time factor, labour dispute with their workers, poor safety record, contract shall be terminated with 7 day notice and Hooghly-CSL shall have the following rights.

- a) To terminate the contract within 7 days of notice forfeiting the Security Deposit
- b) To initiate alternative arrangements at the risk and cost of the contractor.
- c) No claim whatsoever will be entertained in this regard from the firm.

17. **DEFECT LIABILITY PERIOD**

The contractor has to guarantee the workmanship for a minimum period of 06 months from the date of successful completion of work, against defective workmanship. Any trouble or defect originating with the workmanship of any works undertaken by contractor arises at any time up to 06 months from the date when the work is successfully completed, and the CONTRACTOR is notified thereof, the CONTRACTOR shall at his own expense and as quickly as possible make such alteration / repairs and replacements as may be necessary to comply with the above guarantees and shall reimburse any costs and expenses incurred by Hooghly-CSL in connection with such trouble or defect. If the contractor fails to take action as above as Hooghly-CSL shall direct, Hooghly-CSL shall be free to take corrective/alternative action at the contractor's cost and risk within a reasonable time.

18. **FORCE MAJEURE**



18.1. Should failure in performance of the contract or part thereof arise from war insurrection, restraint imposed by government, act of legislature or other statutory authority or illegal strike, riot, legal lock-out, flood, fire, explosion, act of God or any inevitable or unforeseen event beyond human control which may be construed as reasonable ground for an extension of time, Hooghly-CSL may allow such additional time as is mutually agreed to be justified by the circumstances of the case. The occurrence/cessation of force majeure situation is to be informed with documentary evidence within 15 days from the date of occurrence/cessation.

## 19. **TERMINATION & LIMITATION OF LIABILITY**

19.1. This contract may be terminated upon the occurrence of any of the following events.

19.1.1. By agreement in writing of the parties hereto;

19.1.2. By the non-defaulting party, upon default by the other party, of any clauses of this contract, if not remedied within fifteen (15) days, or such longer time as may be agreed upon by the parties, after receipt of notice thereof in writing from the non-defaulting in party.

19.1.3. By the other party, upon either parties:

- (i) Making the assignment for the benefit of creditors, being adjudged a bankrupt or becoming insolvent; or
- (ii) Having a reasonable petition filed seeking its' dissolution or liquidation, not stayed or dismissed within sixty (60) days; or
- (iii) Ceasing to do business for any reason.

19.1.4. In cases where maximum limit of LD is reached and still the items are not delivered.

19.1.5. For fraud and corruption or other unacceptable practices.

19.1.6. Upon expiry or termination of this Contract, neither party shall be discharged from any antecedent obligations or liabilities to the other party under this Contract unless otherwise agreed in writing.

19.2. Hooghly-CSL may by notice in writing to supplier terminate the order after issuing due notice i.e. '7 days' notice period. Hooghly-CSL shall be entitled to compensation for the loss limited to the order value.

19.3. Liability maximum that can be claimed by the supplier shall be limited to what is due to be and has been paid by Hooghly-CSL for the material delivered /work done as per the payment milestones.

## 20. **POWER OF ATTORNEY**

The tenderer(s) shall have to sign in each page of the tender documents with official stamp as a token of his acceptance of the conditions stated therein. The person signing the tender form on behalf of another or on behalf of a firm, shall enclose to the tender, a

Power of Attorney or the said deed duly executed in his favor or the partnership deed giving him such power showing that, he has the authority to bind such other persons or the firm, as the case may be, in all matters pertaining to the contracts. If the Person so signing the tender, fails to enclose the said Power of Attorney, his tender shall be liable for being summarily rejected. The Power of Attorney shall be signed by all partners in the case of partnership concern, by the proprietor in the case of a proprietary concern, and by the person who by his signature can bind the company in the case of a Limited Company.

## 21. **ARBITRATIONS**

21.1. Any disputes arising during the execution of the contract shall, in the first instance be settled by mutual discussions and negotiations. The results of such resolution of dispute shall be incorporated as an amendment to the contract, failing which the parties can resort to arbitration.

21.2. If any dispute, disagreement or question arising out of or relating to or in consequence of the contract, or to its fulfillment, or the validity of enforcement thereof, cannot be settled mutually or the settlement of which is not herein specifically provided for, then the dispute shall within thirty days from the date either party informs the other in writing that such disputes, disagreement exists, be referred to arbitration. The arbitrators shall be appointed and the arbitration proceedings shall be conducted in accordance with and subject to the Arbitration and Conciliation Act, 1996 (No. 26 of 1996) as amended from time to time and the decision of the Arbitrators shall be final and binding on the parties here to. The arbitration will be done by a Board comprising one officer nominated by each party, and a mutually agreed Umpire. Each party shall bear its own cost of preparing and presenting its case. The cost of arbitration shall be shared equally by the parties unless the award provides otherwise. The enforcement of the award shall be governed by the rules and procedures in force in the State in which it is to be executed. Performance under this Contract shall however, continue during arbitration proceedings and no payment due or payable by the parties hereto shall be withheld unless any such payment is or forms a part of the subject matter of arbitration proceedings.

## 22. **SAFETY OF PERSONNEL AND FIRST AID**

22.1. The contractor shall be entirely responsible for the safety of all the personnel employed by him on the work. In this regard, he may adopt all the required safety measures and strictly comply with the safety regulations in force. Detailed information and references available with HSE department of Hooghly-CSL.

22.2. The Contractor may arrange to suitably insure all his workmen/ other personnel in this regard. Hooghly-CSL will not be responsible for any injury or illness to the Contractor's workmen/other personnel during execution of the works due to whatsoever reasons.

22.3. In this regard, the Contractor will have to fully indemnify Hooghly-CSL against any claims made by his workmen/other personnel.

22.4. The Contractor shall provide and maintain so as to be readily accessible during all working hours, a first aid box with prescribed contents at every place where he employs contract labour for executing the works.

22.5. Occupational Health, Safety & Environmental Requirements: Contractor is deemed to comply with the occupational health, safety and environmental policy of the company.

23. **SUB CONTRACTING AND ASSIGNMENT**

23.1. Contractor shall neither assign nor transfer the Purchase Order/ Work Order nor shall any share or interest therein in any manner or degree be transferred or assigned by Contractor to a third party without prior consent in writing of Hooghly-CSL.

23.2. Contractor shall not contract with any subcontractor and/or vendor without the prior written consent of Hooghly-CSL. Such consent shall not relieve the Contractor from any of his responsibilities and liabilities under the Purchase Order/ Work Order. In addition, Contractor shall ensure that the terms and conditions of any such contract shall comply with and correspond to the terms and conditions of the Purchase Order/ Work Order.

24. **INDEMNITY**

24.1. The firm shall indemnify Hooghly-CSL and keep harmless against any or all claims, liabilities, damages, losses, costs, charges, expenses, proceedings and actions of any nature whatsoever made or instituted against Hooghly-CSL directly or indirectly by reason of:

- a. Any wrongful, incorrect, dishonest, criminal, fraudulent or negligent work, misfeasance, disregard of duties by personnel of the firm; and/or
- b. Any theft, robbery, fraud or wrongful act or omission by personnel of the firm.

24.2. The service provider shall indemnify Hooghly-CSL or its officers against any claims arising out of accidents or injuries to workmen or other persons or damage to other property which may arise during the execution of the contract or from breach of any Law or Regulation prior to delivery and acceptance of the items at Hooghly-CSL.

24.3. Under no circumstances Hooghly-CSL will be responsible for any statutory compliance related to Labor, Central/State Government if any.

25. **OVERWRITING & CORRECTIONS**

Tenders shall be free from overwriting or erasures. Corrections and additions, if any, shall be duly attested and a separate list of such corrections shall be attached with the offer.

26. **SECURITY CLAUSE**

26.1. The CONTRACTOR shall be responsible to ensure that all persons employed by them in the execution of any work in connection with this contract are aware of the provisions of the official secrets act 1923 and to comply with the same. The CONTRACTOR shall also ensure secrecy of design, construction, equipment and completion of the vessel. Any information provided to you under this contract is to be treated as strictly confidential and is not to be disclosed to any person or persons not concerned therewith.

26.2. All documents under this Contract transferred between the parties shall be treated as UNCLASSIFIED unless explicitly marked.

26.3. The CONTRACTOR shall ensure that their organization, suppliers/ installation agency/test and trials teams etc. shall not communicate for use in advertising, publicity, sales release or in any other medium, system details, photographs and reproduction of equipment and their fitment on board Navy/coast guard/private owner vessels except without written approval from the competent authority of Hooghly-CSL.

27. **DAMAGE OF MATERIALS / EQUIPMENTS**

The contractor will ensure that no damage is caused to the materials, due to negligence and / or any reason whatsoever by the contractor's man. The cost of damage will be suitably recovered from vendor's bills.

28. **INDIVIDUALITY OF CONTRACT**

This Contract should be treated as an individual contract and should not be related with other orders with Hooghly-CSL in respect of progress of work or payment.

29. Acknowledgement of the Purchase order/Work order by signing and returning a copy of same within 3 days is required once the order is placed to vendor. If acknowledgement is not received, it will be presumed as accepted.

  
विक्रम सिंह  
Vijay Singh  
अधीक्षक (उप-संविदा एवं वाणिज्यिक)  
Manager (Subcontract & Commercial)  
होर्गली कोचीन शिपयार्ड लिमिटेड  
Hooghly Cochin Shipyard Limited

For Hooghly Cochin Shipyard Limited

**GENERAL TERMS & CONDITIONS**

1. Specific resources required/employed for the job: The contractor shall deploy and submit details of resources (equipment and manpower) of adequate capacity and quantity to be specifically provided for subject works. Details to be submitted after award of order, prior start of work.
2. The contractor/bidder must have a site-in charge/ supervisor to execute work, with a minimum experience of 3 yrs. In similar works;
3. The Contractor shall provide the minimum wage rate as prescribed by the Central Govt. to their workmen/s.
4. The Contractor shall have to engage men on round the clock basis and also on Sundays and holidays, if required. Work has to be completed to the satisfaction of Hooghly Cochin Shipyard Engineers deputed for the job. The job should be completed at the time specified by the supervising Engineer for each stage of work.
5. The upper age limit of all workers and supervisors employed by the contractor and those contractors who do or supervise the job themselves shall be as per the prevailing rules of Hooghly-CSL.
6. **For fabrication purpose all consumable like Welding Electrode, cutting wheel, grinding wheel, portable pipe bending machine, welding machine, grinding machine, etc is in vendor scope.**
7. The work will be undertaken by only qualified welders of the contractor. Towards this, Hooghly-CSL will provide the WPS and PQR. Welders will have to be qualified by Class by Hooghly-CSL. **The subcontractor must pay for the welder qualification, testing and certification charges to Hooghly-CSL on actuals. The contractor must retain the qualified welders till the completion of the project.**
8. Work will be undertaken and inspected as per the quality standards provided by Hooghly-CSL, and approved by CLASS and Owner of the vessels.
9. Area and steel skids will be provided by Hooghly-CSL, leveling of the skid will be undertaken by contractor to the satisfaction of Hooghly-CSL QC. Required production aids shall be arranged by Contractors.
10. The contractor shall arrange to collect and clean up every day all waste, scraps, debris, etc. generated by the work men while working onboard the vessel and other locations and dispose the same suitably at his cost to the full satisfaction of Hooghly-CSL. In case any failure on his part to comply with this requirement, Hooghly-CSL will arrange the required cleaning entirely at the contractor's cost.
11. Assistant General Manager (P&P) or his authorized representative will be the Officer-in-charge of this Contract.

12. Material supplied by Hooghly-CSL may not be in the required size and shape. These may be cut and prepared after proper nesting by the Contractor. Special care to be taken to reduce wastages. Shortage of any material (supplied by Hooghly-CSL) arising out of excess wastages due to improper planning shall have to be made up by Contractor free of cost.

13. The contractor shall be responsible for any damage caused to the material supplied by Hooghly-CSL. Compensation with penalty for damage or loss of the item will be recovered from the Contractor, in the event of loss or damage.

14. Any particulars/literature/information/certificates required by the Shipyard in connection with the work is to be forwarded free of cost.

15. All correspondence with the Shipyard to be in English language. All documents and plans to be in English language and in metric units.

16. Contractor to provide all personnel protective items like safety helmets, gloves, welding shields, goggles, leg guards, safety belts, boiler suit, safety shoes etc. to their employees.

17. The firm shall be solely responsible for the payment of wages, salaries and other legal dues of its personnel who are employed or deployed by it from time to time. The firm shall promptly pay all due salaries and wages to its personnel providing service. Hooghly-CSL reserves the rights to ask the firm to submit satisfactory evidence of payment due, salaries etc. In any event, Hooghly-CSL shall not be liable for any payments, dues, wages and salaries of the personnel deployed by the firm.

18. Necessary Insurance Coverage for the contractor's materials / equipment / vehicle including Third Party liability and for the workmen (covering Workmen's Compensation Act) engaged by the Contractor are to be taken at his cost. If any accident/injury occurs to any other persons/public due to proven negligence/non-adherence to relevant safety and other precautions on the part of Contractor/its employees, the contractor shall remain liable to pay necessary compensation and other expense, as decided by appropriate authorities.

**For Hooghly Cochin Shipyard**

**SPECIAL TERMS & CONDITIONS (TWO-BID SYSTEM)**

**1. Common Requirements from the Bidders:**

Following documents are required to be submitted by the bidders along with the Techno-commercial Bid (Part – I) submission:

- a. The Bidder should enclose copy of statutory documents **PAN, GST registration certificate, Income tax returns for last three FY (2021-22, 2022-23, 2023-24)** or of **AY (2022-2023,2023-2024, 2024-25)**.
- b. Audited Balance sheets showing turnover, Profit & Loss account of the firm for the preceding 03 years, FY (2021-22, 2022-23, 2023-24) should be submitted along with the application for prequalification.

**2.MODE OF SUBMISSION OF TENDERS:**

- Tenders should be submitted in two separate files as **PART-I "TECHNO-COMMERCIAL"** & **PART-II "PRICE"** indicating the tender number, due date of the tender in the Mail and addressed to The Assistant General Manager (Materials), Hooghly Cochin Shipyard Limited, Nazirgunge Unit, Howrah. Tender to be submitted by Email only.
- Bidders are requested to submit the bid by e-mail (**Price part password protected**) to the following email addresses clearly mention the tender reference in the subject line for easy identification:

[vijay.singh@hooghlycsl.com](mailto:vijay.singh@hooghlycsl.com) / [abhay.pratap@cochinshipyard.in](mailto:abhay.pratap@cochinshipyard.in)

- While submitting the bid, bidders are requested to note that the e-mail ID starting with following words may probable **be treated as spam, not always necessary-**  
*info, support, admin, sales, customer support, helpdesk, mail, mail admin, billing, hello, careers.*

**3.TECHNO-COMMERCIAL PART SHOULD CONTAIN FOLLOWING DETAILS:**

- a. Stamped and signed copy of all pages of **tender document and corrigenda (if any)** with all supporting documents (as applicable);
- b. Financial documents as mentioned in "**Common Requirements**" of Annexure-1;
- c. **Signed Copy of un-priced Price bid (Annexure-6) (Price bid without price & with percentage of taxes & duties and details like "quoted/Nil/included" need to be mentioned for each line item.)**
- d. Signed and stamped copy of Technical Specification / Scope of Work as per **Annexure** with supporting documents if required
- e. Signed and stamped copy of tender terms and conditions
- f. Checklist duly undersigned with remarks if any.
- g. Vendor Details, NEFT mandate Form

- h. List of Deviation (if Any) ,
- i. Security Deposit formats
- j. Power of Attorney document, Self-Declaration
- k. Details of Legal Case(s) pending

**All documents provided along with techno-commercial part should be stamped and undersigned. Hooghly-CSL reserves the right to reject the bid in case of any discrepancies on the mentioned aspect.**

**4. PRICE PART:**

The price part should contain the following details:

- The price correspondent to each item;
- Taxes as applicable

**The price bid to be offered in the given format (Annexure – 6). Deviations to the format as given would be liable to decline of the bid so submitted.**

5. **Validity:** The offer should be valid for a minimum period of **3 (Three) months** of date of tender opening.
6. Hooghly-CSL reserves the right to alter, modify the scope of supply, at their discretion.
7. Un-priced bid to be submitted along with techno-commercial part (Part – I – Techno-commercial Bid) with details like percentage of taxes & duties applicable & details like “quoted/nil/included” to be mentioned for each line item as per Annexure-6.
8. Tenders should be submitted through E-mail only. No hard copy of the tender documents will not be accepted and may subject to rejection of the bid as a whole by the Hooghly-CSL authority.
9. **Price part should be submitted exactly in the Price Format as provided (Annexure 7).**  
Price should be quoted separately for each item shown in the format. Combining of figures against more than one item and ambiguous clauses will lead to rejection of the bid.
10. Unprotected Price Bids/ Price Bids which are not password protected will be subject to rejection/disqualification of bid and Hooghly-CSL as a whole reserves the right to cancel out such bids.
11. Check lists, technical & commercial, duly filled & signed should be submitted along with Part-I "Techno-Commercial" bid. Non-receipt of this document may lead to rejection of the offer.
12. The Techno-commercial part alone will be opened initially on the due date of tender. The price part will be opened only after evaluation of the Techno commercial part. Firms will be intimated the date of opening of the price part, whose Techno-commercial bid is acceptable, in due course. *Tenderers shall not be allowed to attend the Techno commercial bid opening.*



13. After submission of quotation / price opening, no unsolicited correspondence will be entertained.
14. Bidders can contact Officer-in-charge of the work which is indicated in the Tender Notice for any clarification before submitting the offer. If clarifications/details are not obtained before the offer is submitted, no claim on this account will be admitted.
15. The bidder shall be deemed to have carefully examined the scope of work, technical specifications, general & special terms and conditions, and other necessities mentioned in the tender and have to satisfied himself as to the nature and character of the works to be carried out, the site conditions and all relevant matters & details.
16. All pages of offers including price bids, supporting documents etc. are to be signed by authorized signatory in each page and company seal should be affixed on each page. In case of non-compliance, offer is liable for rejection.
17. Bidder should make sure that they comply with all the techno-commercial details in addition to adhere to all technical specifications during the whole process (i.e. Starting from bid submission to carry out scope of work as per work agreements and as applicable) and provide necessary MSE/NSIC Certificates to avail exemptions, if applicable.
18. Participants/Vendors are requested to obtain clarifications, if any, and carefully study the documents and the scope of services and Hooghly-CSL, before submitting your offer.
19. If any case of the above conditions is not acceptable to the tenderer, it should be specifically indicated in the tender, failing which it will be presumed that all the terms and conditions are acceptable.
20. Hooghly-CSL have full right upon deviations, if any, including rejecting the partial scope/ complied offers.
21. Offers should be clear and unambiguous. Incomplete/ambiguous offers are likely to be rejected.
22. Bid Submission shall include Amendment / corrigendum / response to pre bid query duly signed and accept (if any).
23. After scrutinization of documents (Part – I) provided by the bidders, and after successful techno-commercial qualification, bidders will be contacted prior to opening of price bid. Passwords will be asked before opening of price bid. Authorized representor is required during the opening of price bid.
24. The bidders are advised to familiarize themselves with the site conditions before quoting.
25. Supplier should depute only persons who are entitled for exemption for income tax in India or any site work. In case the supplier does not depute such persons, the tax liability will be to supplier's account.
26. After submission of tender, no unsolicited correspondence will be entertained.

27. Hooghly Cochin Shipyard Limited does not bind itself to accept the lowest or any tender but reserves to itself the right to reject any or all or a part of any tender at its discretion.
28. During the evaluation of tender, officer-in-charge may seek clarifications from the bidders. Clarification if any shall be given in writing/e-mail. Officer-in-charge's decision will be final and binding on the bidder.
29. All applicable taxes, duties, transportation, delivery, etc at Hooghly-CSL Nazirgunge, should be included in the rate quoted, unless specified otherwise. Hooghly-CSL reserves the right for the deduction of taxes and duties as applicable from the bill or invoice.
30. Bidders to note that no advance payment will be made by Hooghly-CSL against purchase order issued.

**For Hooghly Cochin Shipyard Limited**

**Techno-Commercial Checklist for Tender for Piping Spools Fabrication, Testing, Onboard Installation & Commissioning of Piping Systems & Hydraulic System for 40T BP ASD Tugs being constructed at Hooghly-CSL, Howrah**

SI. No.	DESCRIPTION	COMPLIANCE		REMARKS
		YES	NO	
1	Submission of Tender in two (2) parts – Techno-commercial bid & Price Bid (Password protected)			
2	Work Completion Period as per Tender			
3	EMD			
4	Validity of offer – 90 Days			
5	Payment Terms acceptance			
6	The Prices offered should remain firm till the completion of work, in case the work order is placed with you.			
7	Have you specified Taxes, duties, levies etc., if any, in the offer?			
8	Signed and stamped copy of unpriced bid (mentioning taxes and duties) and “quoted/nil/included” against each line item as per Annexure 6 to be included in the techno- commercial offer. Please confirm			
9	Compliance with Pre-qualification criterion with supporting documents			
10	Self-attested copy of PAN Card, GST, ESI, EPF and MSME/NSIC registration certificate.			
11	Disputes in connection with contract subject to jurisdiction of courts at Kolkata, India.			
12	Defect Liability Period as per relevant clause in the terms of enquiry.			
13	L.D. payable as per relevant Clause in the General terms of enquiry.			
14	Termination of contract/Risk purchase as per relevant clause in the General terms of enquiry.			
15	ITR, Balance Sheets, Profit & loss statement for FY 2021-22, 2022-23 & 2023-24 submitted with the Bid.			
16	List of Deviations to be submitted as per Annexure 8			
17	Supplier should have minimum average annual turnover of <b>Rs. 45 Lakhs</b> as on 31 <sup>st</sup> March (FY 2020-21, 2021-22 and 2022-23) Supporting document to be submitted along with technical bid			
18	Contractor to provide minimum wage structure as prescribed by <b>Central Govt.</b>			
19	Modification works if envisaged later, to be done and calculated at unit rates agreed / established under this contract.			

**PRICE BID FORMAT****PART A: PIPE SPOOL FABRICATION RATE FOR CARBON STEEL & SS PIPES**

Sl. No.	Category	Approx. Inch Diameter / Ship <b>(IND) (A)</b>	Unit rate <b>(B)</b>	Total Rate For One Ship <b>(C=A*B)</b>	Req. for No. of Ships <b>(D)</b>	TOTAL <b>(E=C*D)</b>
1	Non-Class Carbon Steel Pipes total	18,715.5				
1.1	32NB to 50NB	8271.5			02	
1.2	65NB to 80NB	6857			02	
1.3	100NB to 150NB	2334			02	
1.4	Above 150NB, 200NB &	1208			02	
1.5	Pipe bending	45			02	
2	Stainless Steel Pipe total	714				
2.1	25NB to 50NB	347			02	
2.2	65NB to 80NB	359			02	
2.3	100NB	8			02	
		TOTAL VALUE FOR ONE SHIP			GRAND TOTAL VALUE	
			GST@.....		GST@.....	
	TOTAL VALUE INCLUDING GST					

**Note:**

1. Quantum of work indicated is for estimation purpose only as per preliminary design progress, actual quantum of work executed at site shall be considered for the payment as per spool drawings issued.
2. Per Inch Dia. quoted rates will also be applicable for modification works, if required.

**PRICE BID FORMAT****PART B: PIPE SPOOL FABRICATION RATE FOR CARBON STEEL & SS PIPES**

Sl. No.	Category	Approx. Inch Diameter / Ship (IND) (A)	Unit rate (B)	Total Rate For One Ship (C=A*B)	Req. for No. of Ships (D)	TOTAL (E=C*D)
3	Non-Class Carbon Steel Pipes total	1665				
3.1	Less than 32 NB	335			04	
3.2	300NB to 550NB	1330			04	
4	Class Carbon Steel Pipes total	245				
4.1	32NB to 50NB	97			04	
4.2	65NB to 80NB	46			04	
4.3	Above 150NB	102			04	
		TOTAL VALUE FOR ONE SHIP			GRAND TOTAL VALUE	
			GST@.....		GST@.....	
	GRAND TOTAL VALUE INCLUDING GST					

**Note:**

- Quantum of work indicated is for estimation purpose only as per preliminary design progress, actual quantum of work executed at site shall be considered for the payment as per spool drawings issued.
- Per Inch Dia. quoted rates will also be applicable for modification works, if required.

**PRICE BID FORMAT****PART C: RATE FOR GALVANISATION/PICKLING/PASSIVATION**

<b>SL. No</b>	<b>Description</b>	<b>Total Weight in Ton (A)</b>	<b>Unit Rate/Ton (B)</b>	<b>Total Rate for One Ship (C=A*B)</b>
1	Hot Dip Galvanizing	<b>20</b>		Rs.....
2	Pickling and primer	<b>6</b>		Rs.....
3	Passivation	<b>0.7</b>		Rs.....
	<b>PART C - TOTAL PRICE</b>			
	<b>GST@....</b>			
	<b>PART C - TOTAL PRICE INCLUDING GST</b>			

**Note:**

1. Non-GI pipes inside and outside of pipes to be ballasted upon completion .
2. After GI process pipes to be cleaned thoroughly to avoid any scales or zinc ash marks.
3. After pickling Outside of pipes to be primer coated approx. 50 micron to avoid corrosion after completion.
4. All ends to be properly closed with plastic end cap to avoid outside particles.

**PRICE BID FORMAT**  
**PART D: ONBOARD INSTALLATION, TESTING & COMMISSIONING**

**Per Meter cost is inclusive of:**

- Onboard Fabrication and Installation of Pipe Supports (Yard will provide MS flat-bars and MS angles only),
- Onboard Installation of Valves and Related Fittings, Gauges and Piping Instrumentations.
- Flushing, Testing & Commissioning of Piping Systems.
- Related fasteners gaskets and U bolts etc (as per Marine / Shipbuilding Standards).

<b>I. CARBON STEEL PIPING - CONSOLIDATED MATERIAL SUMMARY</b>							
<b>Sl. No.</b>	<b>Description</b>	<b>Size / Dimensions</b>	<b>Material</b>	<b>Total Req. Per Ship (A)</b>	<b>UOM</b>	<b>Installation Price / Meter (B)</b>	<b>TOTAL PRICE (For One Ship) (C = A*B)</b>
1	PIPE SMLS	DN80	ASTM A53 Gr B	264	Mtr		
2	PIPE SMLS	DN65	ASTM A53 Gr B	247	Mtr		
3	PIPE SMLS	DN50	ASTM A53 Gr B	480	Mtr		
4	PIPE SMLS	DN40	ASTM A53 Gr B	317	Mtr		
5	PIPE SMLS	DN32	ASTM A53 Gr B	108	Mtr		
6	PIPE SMLS	DN200	ASTM A53 Gr B	49	Mtr		
7	PIPE SMLS	DN150	ASTM A53 Gr B	25	Mtr		
8	PIPE SMLS	DN125	ASTM A53 Gr B	27	Mtr		
9	PIPE SMLS	DN100	ASTM A53 Gr B	49	Mtr		
10	TUBE 1.5THK	Ø8	ASTM A192 Gr B	45	Mtr		
11	PIPE SMLS	DN25	ASTM A53 Gr B	211	Mtr		
12	PIPE SMLS	DN20	ASTM A53 Gr B	108	Mtr		
13	PIPE SMLS	DN15	ASTM A53 Gr B	101	Mtr		
14	PIPE SMLS	DN550	ASTM A53 Gr B	3	Mtr		
15	PIPE SMLS	DN450	ASTM A53 Gr B	8	Mtr		
16	PIPE SMLS	DN400	ASTM A53 Gr B	22	Mtr		
17	PIPE SMLS	DN350	ASTM A53 Gr B	20	Mtr		
18	PIPE SMLS	DN300	ASTM A53 Gr B	2	Mtr		

<b>II. STAINLESS STEEL PIPING - CONSOLIDATED MATERIAL SUMMARY</b>							
<b>Sl. No.</b>	<b>Description</b>	<b>Size / Dimensions</b>	<b>Material</b>	<b>Total Req. Per Ship</b>	<b>UOM</b>	<b>Installation Price / Meter (B)</b>	<b>TOTAL PRICE (For One Ship) (C = A*B)</b>
1	PIPE SMLS	DN25	A312, SS316L	10	Mtr		
2	PIPE SMLS	DN40	A312, SS316L	10	Mtr		
3	PIPE SMLS	DN50	A312, SS316L	27	Mtr		
4	PIPE SMLS	DN65	A312, SS316L	27	Mtr		
<b>III. CLASS APPROVED PIPING - CONSOLIDATED MATERIAL SUMMARY</b>							
<b>Sl. No.</b>	<b>Description</b>	<b>Size / Dimensions</b>	<b>Material</b>	<b>Total Req. Per Ship</b>	<b>UOM</b>	<b>Installation Price / Meter (B)</b>	<b>TOTAL PRICE (For One Ship) (C = A*B)</b>
1	PIPE SMLS	DN80	ASTM A106 Gr B	4.5	Mtr		
2	PIPE SMLS	DN400	ASTM A106 Gr B	1.5	Mtr		
3	PIPE SMLS	DN550	ASTM A106 Gr B	1.5	Mtr		
4	PIPE SMLS	DN15	ASTM A53 Gr B	1.5	Mtr		
5	PIPE SMLS	DN40	ASTM A53 Gr B	1.5	Mtr		
6	PIPE SMLS	DN50	ASTM A53 Gr B	6	Mtr		
7	PIPE SMLS	DN65	ASTM A53 Gr B	1.5	Mtr		
8	PIPE SMLS	DN200	ASTM A53 Gr B	4.5	Mtr		
<b>GRAND TOTAL (FOR ONE SHIP):</b>							
<b>GST @....</b>							
<b>TOTAL VALUE FOR ONE SHIP INCLUDING GST</b>							

**Note:**

1. Quantum of work indicated is for estimation purpose only as per preliminary design progress, actual quantum of work executed at site shall be considered for the payment as per spool drawings issued.
2. Per Meter quoted rates will also be applicable for modification works.



**PRICE BID FOR PIPING WORKS OF 40 TON ASD TUG PRICE BID FORMAT**

SI. NO.	WORK DESCRIPTION	Qty.	UoM	TOTAL VALUE FOR ONE SHIP (A) (UOM - LS)	GST APPLICABLE @..... (B)	REQUIRED FOR NO. OF SHIPS (C)	TOTAL VALUE D=(A+B)*(C)
1	PART A Pipe Spools Fabrication for Carbon Steel & Stainless-Steel Pipes	1	LS			02	
2	PART B Pipe Spools Fabrication for Carbon Steel & Stainless-Steel Pipes Less than 32 NB and more than 300NB	1	LS			04	
3	PART C Galvanization / Pickling / Passivation	1	LS			02	
4	PART D Onboard Installation & Commissioning of Piping Works	1	LS			04	
5	PART E Onboard Hot-Works / Welding, (OBDS, Penetration Sleeves, Deck & BHD Penetrations, Tank Penetrations Etc., Pre-Launch Works Onboard)	1	LS			04	
6	PART F Hydraulic Piping Works (Turnkey onboard installation & commissioning as per Yard supplied BOM / Material)	1	LS			04	
				TOTAL VALUE FOR ONE SHIP			
				GST @...			
				GRAND TOTAL VALUE INCLUDING GST			

7	PART G	Piping Modification Works (Limited to 20% of each line item PART A to PART F) (Modification works if envisaged later, to be done and calculated at unit rates agreed / established under this contract.)					04	
*PART G – Modifications Work cost is not to be considered for L1 determination.								

Signature:

Address of the contractor:

Date:

Seal:

**Note:**

- 1.1. Prices are to be quoted in the Pricing Format. The quotations to be submitted in the company letter head.
- 1.2. Quotations shall be submitted as Password Protected File. The bidders are advised to share the password through only SMS while opening the quotations.
- 1.3. L1 will be determined based on the total amount basis without taxes
- 1.4. Cost of Pipe spool fabrication will be = Size of pipe in inch x No. of joints (of that size) X Inch Dia. Rate in the respective category.
  - Each Butt joint is considered as one joint.
  - Each Flange fitment, inside and outside welding (Fillet) is considered as two joints.
  - Sleeve welding both ends considered as one joint.
  - Branch connection butt joint is considered as one joint
  - Pipe bending by cold bending process is considered as 0.5 joints for charges.
  - For joints which are only tack welded is considered as 0.5 joints for charges.
- 1.5. Rate quoted for Inch Diameter (IND) includes all activities involved in that joint such as edge preparation, fitment, welding of flanges, sleeves, elbows, tees, reducers, bends, branch pipes, butt welding, fillet welding etc.
- 1.6. Root welding should be TIG welding.
- 1.7. Fabrication also includes marking, cutting, edge preparation, cold bending, branch connections, profile cutting,

preparation, testing, inspection etc. as per drawings, specifications/ instructions of Officer- in - Charge.

- 1.8. Cost for electrodes/filler wire, consumables, galvanizing, pickling and passivation, pressure testing, inspection etc. shall be inclusive in the quoted rate.
- 1.9. All costs for the satisfactory completion of pipe spool fabrication and Primer coating or Hot -dip galvanizing shall be included in PART A/B.

**Note:**

1. The quoted price will be valid for a period of 3 (three) months.
  2. Quoting for all serials is mandatory. Partially quoting for few serials shall result in rejection of the bid.
  3. L1 Bidder will be decided on total amount basis (**Modification works is not considered for L1 determination**), without considering Taxes.
  4. Rate agreed upon as per quotation shall remain firm and fixed till conclusion of contract.
  5. Bidders shall quote total amount in figures and in words. Corrections and additions if any must be attested / duly signed by the bidder. In the case of error in multiplication / addition in amount calculated, unit rate quoted will be considered as correct and the amount will be calculated accordingly. Conditional rebates & discounts, incomplete/ambiguous offers are likely to be rejected.
  6. Bidder has to submit the price bid as mentioned in the format only, otherwise bid will be rejected
  7. Un-priced bid to be submitted along with techno-commercial part (**Part – I – Techno-commercial Bid**) with details like "**quoted/nil/included**" to be mentioned for each line item
- \*Any modifications or alterations or additional notes added to the above format will straight away leads to rejection of the offer.

Signature:

Address of the contractor:

Seal:

<u>COMPLIANCE STATEMENT- LIST OF DEVIATIONS</u>		PAGE 1 OF 1
<b>Tender Name:</b> Piping Spools Fabrication, Testing, Onboard Installation & Commissioning of Piping Systems, Hydraulic System Piping for 40T BP ASD Tugs being constructed at Hooghly-CSL, Nazirgunge unit, Howrah.		
TENDER NO: Hooghly-CSL/OPS/SB/TEN/2025/022 ,		Dated- 12.03.2025
<b>DATE:</b>		
We hereby confirm and truly declare that our Offer / Bid No. ....dated .....is in full compliance with the documents issued against the Tender No. ....dated ....., except for the deviations listed below:		
<b>LIST OF DEVIATIONS</b>		
Sl. No.	Description / Tender Reference	Reasons for Deviation
Name of tenderer:		
Date:	Name & Designation	Seal &
Signature		
(Company Seal)		

**Vendor details (to be submitted along with TECHNICAL BID)**

<b>1</b>	Name of Bidder/Firm	
<b>2</b>	Registered office Address of Company/firm in Kolkata/Howrah: Local office address at Kolkata/Howrah (if held):	
<b>3</b>	Telephone No./Fax No./Mobile No	
<b>4</b>	E-mail address:	
<b>5</b>	Names of the contact person & Designation: (of person in connection with this tender) :	1) 2) 3)
<b>6</b>	Type of Entity-Pro praetorship/Partnership firm/company/NSIC/MSE Category etc. (Please attach registration certificate of Firm/Partnership agreement/proprietorship documents)	
<b>7</b>	Cost of Tender Details (DD No. Name of Bank)	
<b>8</b>	EMD Details (DD No. Name of Bank)	
<b>9</b>	PAN Card Number (Self-attested copy of PAN card has to be Submitted)	
	GST Registration No. (Self-attested copy has to be Submitted)	
<b>10</b>	Whether the agency has been blacklisted/debarred or given tender holiday or contract terminated before expiry of the contract period by any govt. autonomous bodies/organizations where bidder has provided services earlier due to deficiencies in service or misconduct etc.	Yes/No (Please tick as applicable) If yes, please furnish details on a separate sheet

**Certified that the above information is true to the best of our belief and information.**

**Place:**

**Date:**

**Signature of Supplier/Authorized signature of firm/agency:**

**Name of Supplier or authorized signatory of firm/agency:**

**Designation:**

NEFT mandate form

(ON THE LETTER HEAD OF THE BIDDER)

**Electronic Payment Mandate Form**

(Mandate for receiving payments through RTGS/NEFT Hooghly Cochin Shipyard Ltd)

- 1) Vendor Name
- 2) Vendor Address with Phone No
  
- 3) Vendor Code
- 4) Permanent Account No. (PAN)
- 5) Particulars of Bank Account
  - a. Name of the Bank
  
  - b. Name of the Branch
  
  - c. Branch Code
  - d. NEFT Code of the Bank
  - e. City Name
  - f. Branch Location
  - g. Branch Telephone No.
  - h. Bank IFSC Code
  - i. 9-Digit MICR Code

**(Where MICR is starting with "0". Please take the correct code from your bank for proper identification of city, bank, branch)**

  - i. Type of the Account (S.B Current or Cash Credit) with code (010/011/013)
  - j. Account Number (as appearing on the cheque book)
- 6) Email Address of Vendor
- 7) Date of Effect of RTGS/NEFT in

your Bank

We hereby declare that the particulars given above are correct and complete. If the transaction is delayed or lost because of incomplete or incorrect information, we would not hold the company responsible.

(.....)  
Signature of Employee

Bank Certificate

We certify that \_\_\_\_\_ has an Account  
No. \_\_\_\_\_ with us and we confirm that the details given above  
are correct as per our records.

Date:

Place: (.....)  
Authorized official of Bank

**Note: Please enclose a cancelled un-signed cheque leaf to enable us to verify the details mentioned above.**

**Form of bank Guarantee towards EMD**

(On stamp paper of value Rs. 200/-)

This deed of GURANTEE made on ..... day of .....Two thousand Eighteen between Hooghly-CSL on the one part and ..... (Name and address of the bank) of the other part is as follows: -

In consideration of the Hooghly-CSL having allowed M/s..... (Hereinafter referred to as 'the Supplier') to submit Tender No..... to them without Earnest Money according to the conditions of such Tender Notification.

We..... (here enter the name of 'the Bank') a Company incorporated under the .....Act and having its registered office at .....(hereinafter referred to as 'the bank') undertake to pay to Hooghly-CSL on demand at Kolkata the sum of money payable as Earnest Money in respect of the Tender No.....made by the Supplier, in case the Supplier withdraws the tender before the date of firmness stipulated or when the tender is accepted by or on behalf of the Hooghly-CSL the Supplier makes default in furnishing the Security Deposit or in entering into an agreement as required by the Hooghly-CSL or otherwise commits any breach of the terms and conditions of the tender.

We, .....Bank Guarantee to pay the amount due and payable under this guarantee without any demur merely on demand from the Hooghly-CSL. Any such demand made on the Bank shall be conclusive as regards the amount due and payable by the Bank under this guarantee. The liability of the surety shall be restricted to ..... Rs .....(Rs..... only)

This guarantee shall not be avoided, released or affected by any variation in the terms of the tender, acceptance or the contract between the Contractor and the Hooghly-CSL or any neglect indulgence or forbearance by the Hooghly-CSL.

This guarantee shall remain in full force and effect during the period that would be taken for the finalization of the tender and till the Hooghly-CSL certifies that the terms and conditions of the said tender have been fully and properly carried out by the Supplier and accordingly discharges this guarantee or for Six Months from the date of issue of this guarantee whichever is earlier. A



notice of the claim under this guarantee may be served on the Bank within Six Months after the said period in which case the same shall be enforceable against the Bank notwithstanding the fact that the same is enforced after the expiry of the said period.

The decision of the CEO, Hooghly-CSL as to whether the occasion or the ground has arisen for the demand of the surety form Bank shall be final. The Hooghly-CSL shall be at liberty to act as though the Bank were the principal debtor.

We, the said Bank lastly undertake not to revoke this guarantee during its currency except with the previous consent of the Hooghly-CSL in writing and agree that any change in the constitution of the said contractor or the said Bank shall not discharge our liability hereunder.

In witness whereof we have hereunto set our hand and seal this. .... day  
.....of.....Two thousand and  
.....

Place:

Date:

**Bank guarantee in lieu of security deposit/  
Warranty guarantee**

To  
HOOGHLY COCHIN SHIPYARD LTD  
(Govt. of India Enterprise)  
Satyen Bose Road,  
Danesh SK Lane (PO),  
Nazirgunge, Howrah,  
West Bengal - 711109.

WHEREAS .....(Name & Address of Supplier) (hereinafter called "**the Supplier**")  
has ..... undertaken, ..... in ..... pursuant ..... of  
Contract.....No.....Dated:.....to ..... execute  
.....(Name of Contract and brief description of works) (hereinafter  
called "**the Contract**").

AND WHEREAS it has been stipulated by **HOOGHLY COCHIN SHIPYARD LTD** (The Buyer – hereinafter called "**Hooghly-CSL**") in the said contract that the Supplier shall furnish **Hooghly-CSL** with a Bank Guarantee for the sum specified therein as security for compliance with the Supplier's obligations in accordance with the Contract.

AND WHEREAS we have agreed to give the Supplier such a Bank Guarantee.

NOWTHEREFORE we.....(Name of the Bank) having its Head Office  
at.....(Address of Head Office) and acting through its branch office  
at.....(Address of the executing branch)(hereinafter called "the Bank") hereby  
affirm that we are the Guarantor and responsible to **Hooghly-CSL**, on behalf of the Supplier  
upto a total of.....(amount of Guarantee) in words).

We, the bank, hereby irrevocably undertake to pay you any amount not exceeding in total the Guarantee Amount upon receipt by us of your demand in writing accompanied by the following documents:

1. Your signed statement certifying that the Supplier is in breach of his obligation(s) under the Contract and the respect in which the Supplier is in breach.
2. Your signed statement certifying that the Supplier has been given a prior written notice by email from you to make good the aforesaid breach and that the Supplier still failed to fulfill the Contract within 30 days of such notice. A copy of such notice given by email to the Supplier shall be attached to the demand for payment.

Any demand for payment should contain your authorized signatures which must be authorized by your bankers or by a notary public.

We, the Bank, further agree that no change or addition to or other modification of the terms of the Contract or of the Works to be performed there under or of any of the Contract documents which may be made between **Hooghly-CSL** and the Supplier shall in any way release us from any liability under this guarantee, and we hereby waive notice of any such change, addition or modification. We, the Bank, further agree that any change in the constitution of the said contractor or the said bank shall not discharge our liability hereunder.

**Notwithstanding** anything contained herein:

1. Our liability under this Bank Guarantee shall not exceed .....(only).
2. This Bank Guarantee shall be valid upto (date) and

3. We are liable to pay the guaranteed amount or any part thereof under this bank guarantee only and only if **Hooghly-CSL** serve upon us a written claim or demand on or before.....(validity date).

Any demand for payment under this guarantee must be received by us at this office during working hours on or before the validity date. Should we receive no claim from you by the validity date, our liability to you will cease and the guarantee will definitely become null and void whether returned to us or not.

Yours truly,  
Signature and seal of the guarantor:.....

Name of Bank:.....

Address:.....Date:.....

[\[1\]](#)An amount shall be inserted by the Guarantor, representing the percentage of the Contract Price specified in the Contract and denominated in respective Dollars / Indian Rupees/Other Currency.

**POWER OF ATTORNEY**

*(On Applicant's Letter head)*

(Date and Reference)

To  
The Assistant General Manager  
Hooghly Cochin Shipyard  
Limited  
Nazirgunge, Howrah-711109,  
West Bengal.

**Subject: Power of Attorney**

Mr. / Mrs. / Ms..... (Name of the Person(s),  
domiciled at  
.....(Address  
)  
acting as..... (Designation and name of the company), and  
whose signature is attested below, is hereby appointed as the Authorized Representative and  
authorized on behalf of  
..... (Name of the  
company) to provide information and respond to **enquiries etc.** as may be required by the  
Employer for the project of .....  
(Project title) and is hereby further authorized to sign and file relevant documents in respect of the  
above.

(Attested signature of Mr.\_\_\_\_\_).

For.....

(Name & designation)

(Company Seal)

**Self-Declaration to be given by the bidder in Letter head**

Bid's Reference No. & Date:

Bidder's Name & Address:

Person to be contacted:

Designation:

Telephone No.:

Fax No.:

Email:

1. We do hereby declare that we have not been debarred/black listed by Hooghly-CSL or by any of the Public Sector Undertaking or Government department etc.

2. If Hooghly-CSL finds that, we have been blacklisted/ debarred by any of the Public Sector Undertaking or Government department, and then Hooghly-CSL can reject the offer or terminate the contract at any point of time. In such case, we are aware that, EMD, security deposit, performance guarantee etc will be forfeited by Hooghly-CSL. Further we are confirming herewith that, any loss that has happened to Hooghly-CSL due to this will be compensated by us.

For and on behalf of the firm  
(Firms Name & Address)

(Signature of Authorized Signatory)

Name:

Designation

Phone No.:

Seal:

Date: .....

Place: .....



**Form of Legal Case (Sample Format)**



Details of legal cases pending against the firm for the last five years

SL. NO.	ORGANISATION AGAINST WHOM THE LITIGATION IS INVOLVED	BRIEF DETAILS OF DISPUTE	AMOUNTS INVOLVED (Rs. ....)	PRESENT STATUS	Remarks



- If no Cases pending please mention as “NIL” and submit the above form.

**SIGNATURE OF BIDDER**

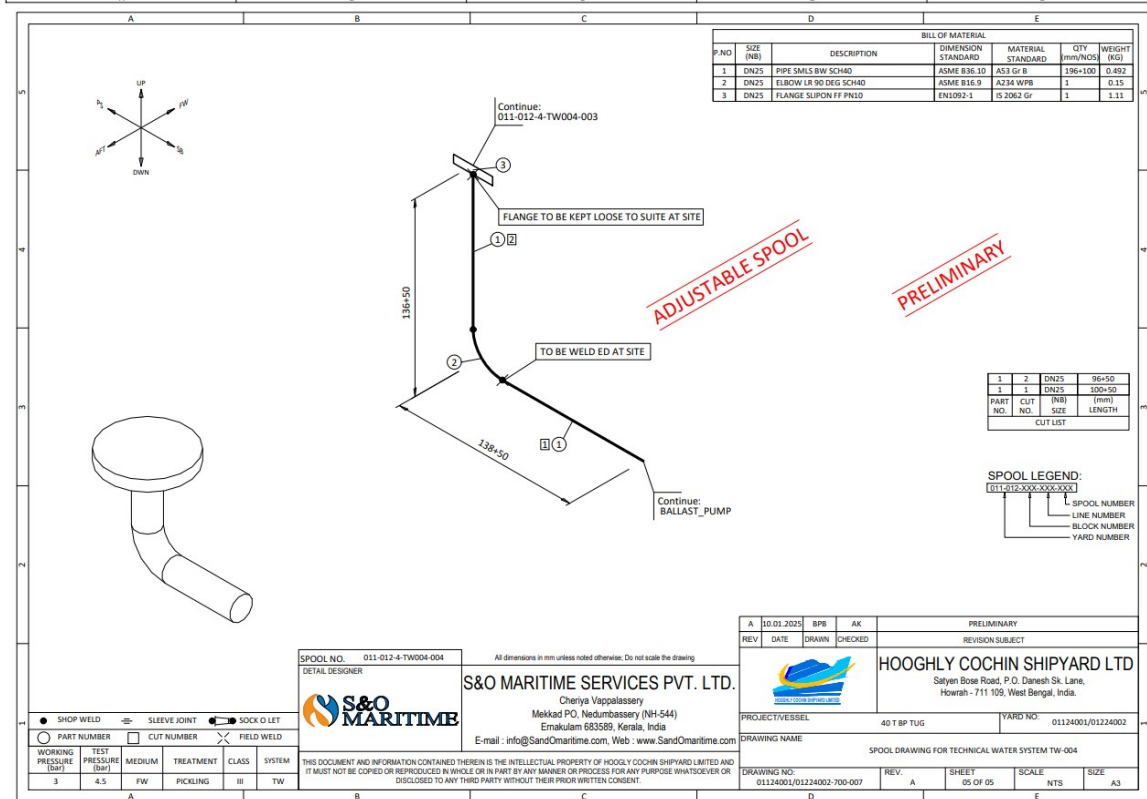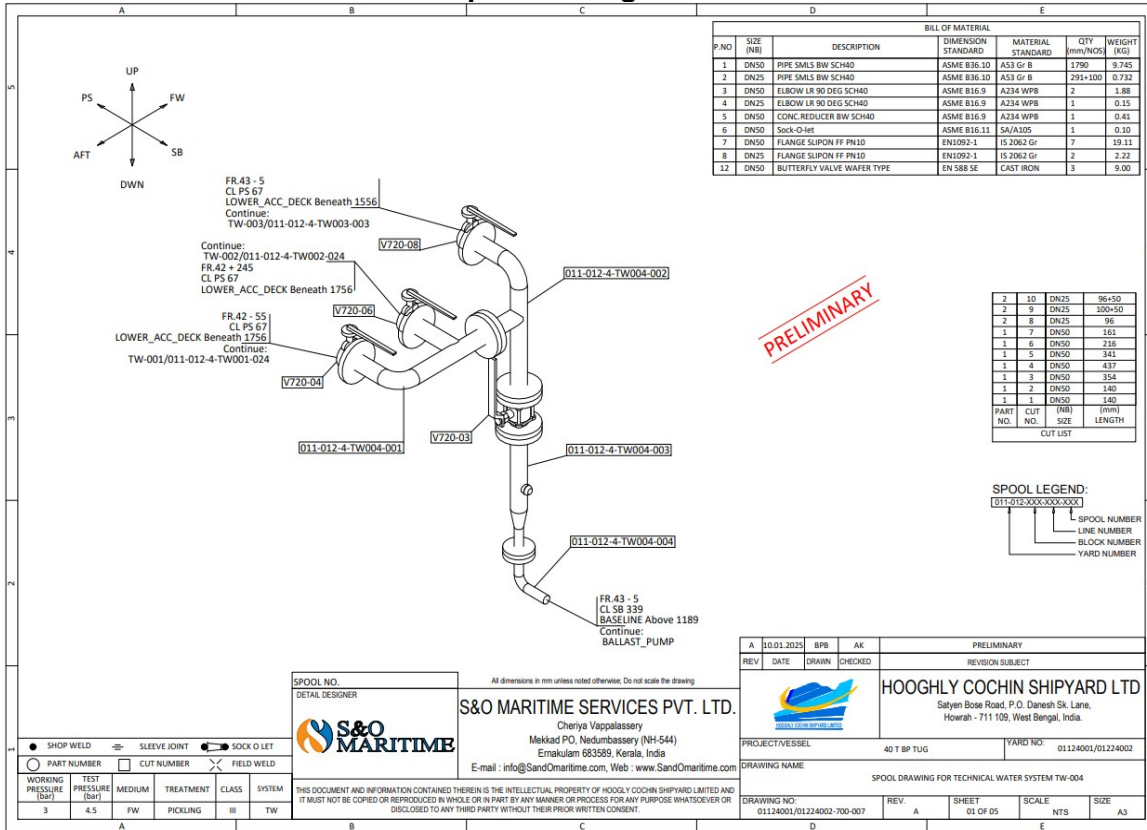

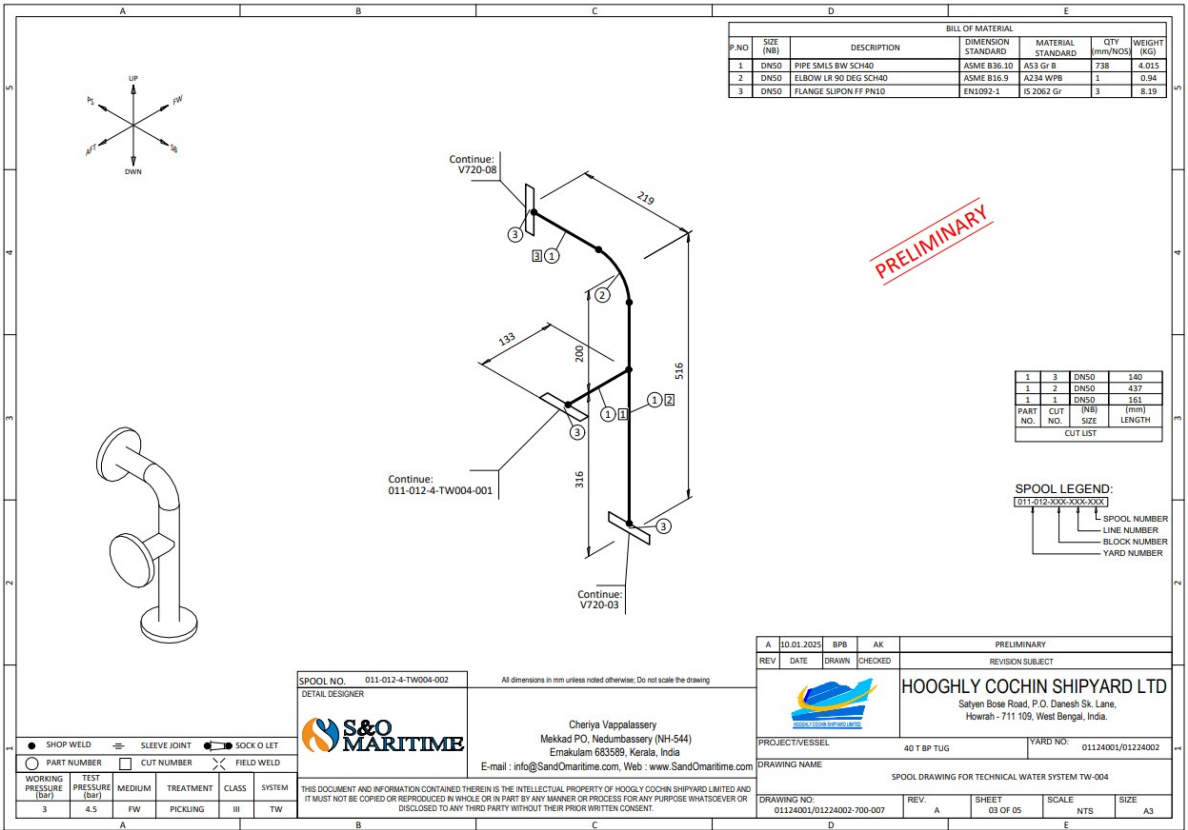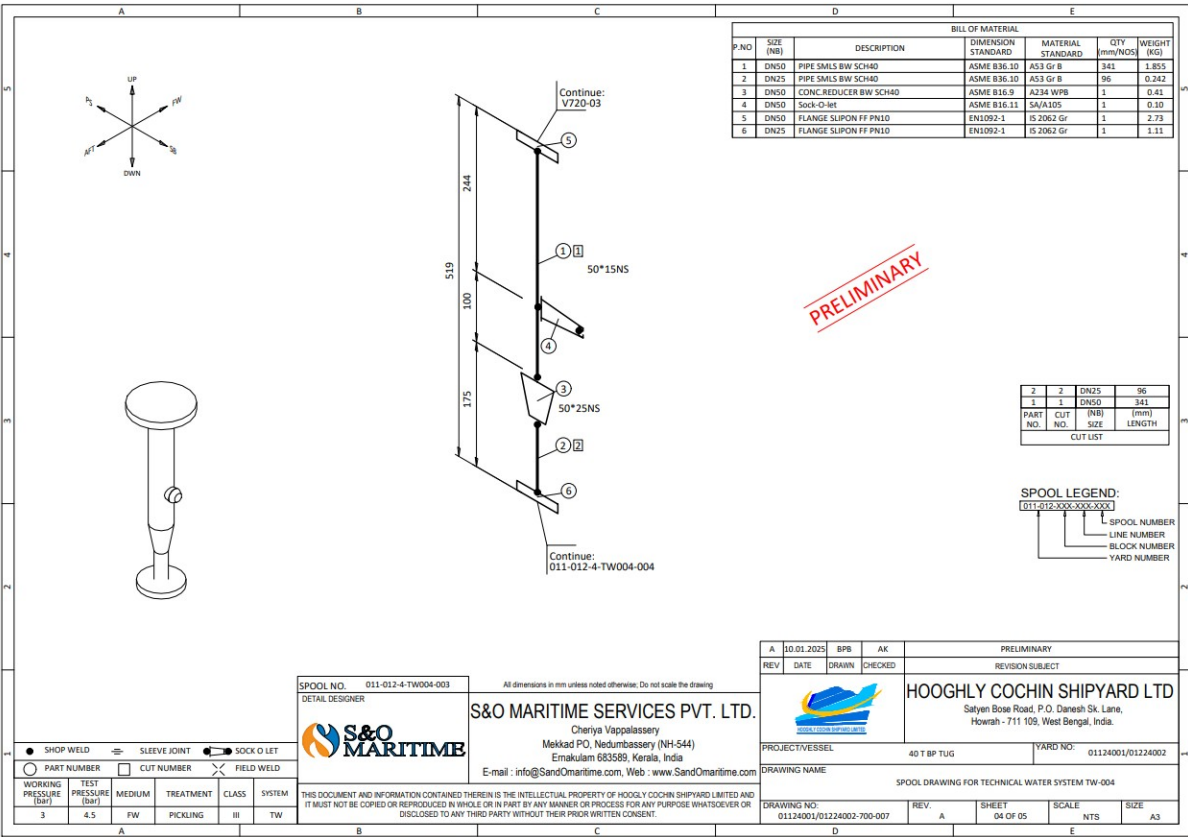



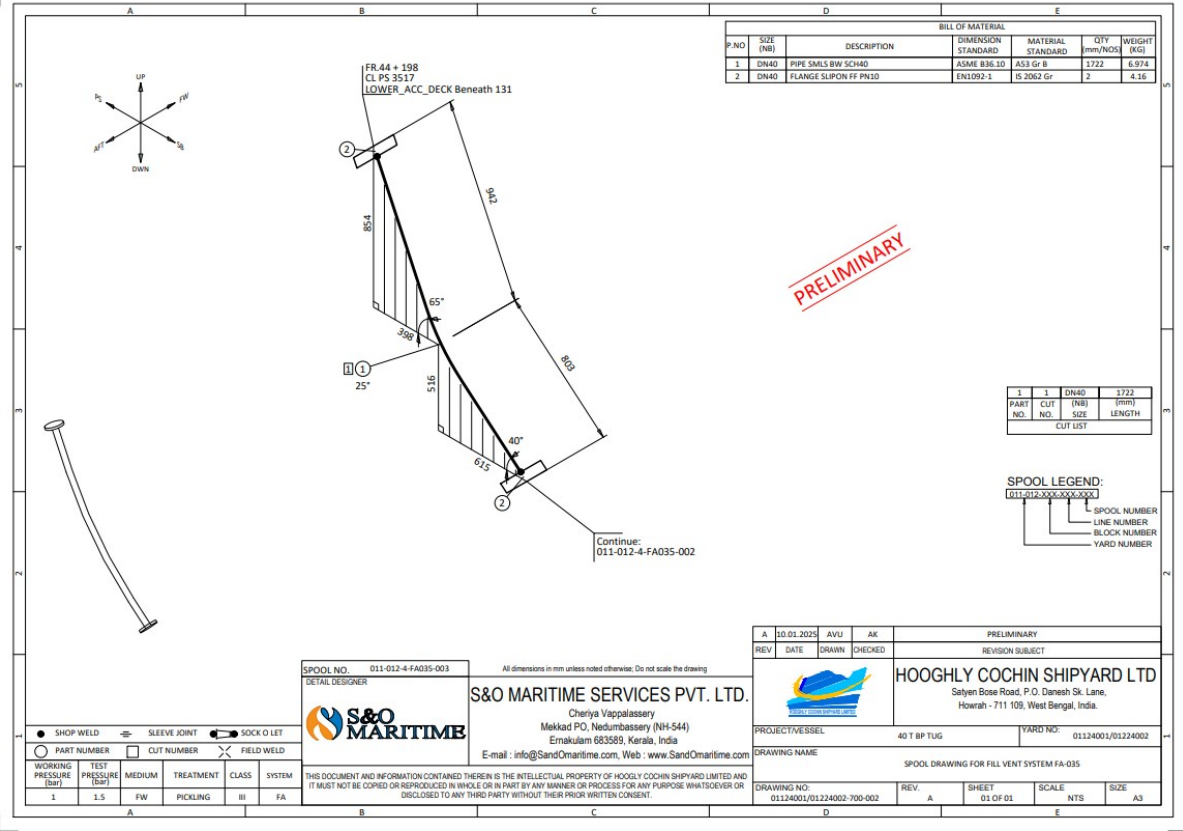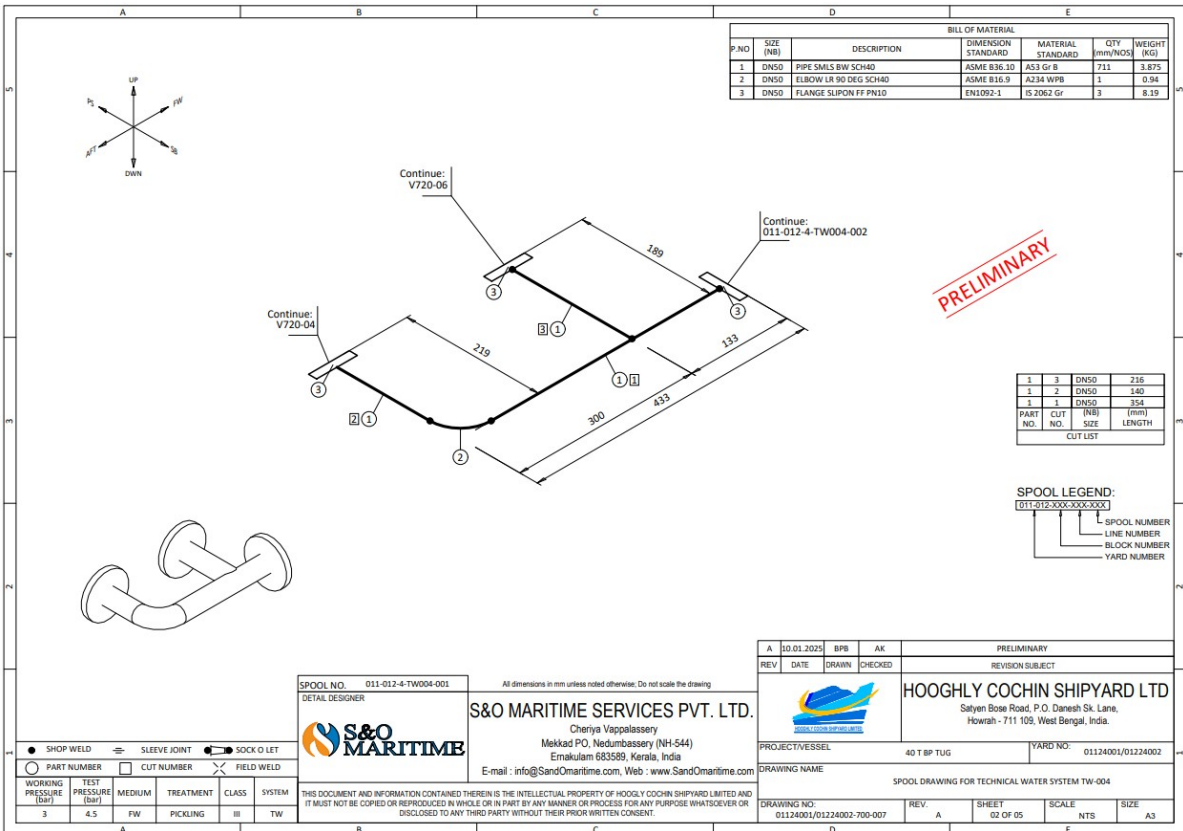

## Encl 1 BOM of Pipe &amp; Fittings per ship Ann. 2 Encl 1

## Annexure 2 Enclosure 1:

Material as per BOM of Pipe and fittings to be provided by yard for spool fabrication. (Qty. given is per ship).

CARBON STEEL PIPING - CONSOLIDATED MATERIAL SUMMARY							
Sl. No.	Item Type	Description	Size / Dimensions	Material	Standard	Total Req. Per Ship	UOM
1	CONCENTRIC REDUCER	CONC.REDUCER BW SCH40	DN80X65	ASTM A234 WPB	ASME B16.9	6	nos.
2	CONCENTRIC REDUCER	CONC.REDUCER BW SCH80	DN80X65	ASTM A234 WPB	ASME B16.9	1	nos.
3	CONCENTRIC REDUCER	CONC.REDUCER BW SCH40	DN80X50	ASTM A234 WPB	ASME B16.9	22	nos.
4	CONCENTRIC REDUCER	CONC.REDUCER BW SCH80	DN80X50	ASTM A234 WPB	ASME B16.9	13	nos.
5	CONCENTRIC REDUCER	CONC.REDUCER BW SCH40	DN65X50	ASTM A234 WPB	ASME B16.9	9	nos.
6	CONCENTRIC REDUCER	CONC.REDUCER BW SCH80	DN65X50	ASTM A234 WPB	ASME B16.9	2	nos.
7	CONCENTRIC REDUCER	CONC.REDUCER BW SCH40	DN65X40	ASTM A234 WPB	ASME B16.9	3	nos.
8	CONCENTRIC REDUCER	CONC.REDUCER BW SCH80	DN65X40	ASTM A234 WPB	ASME B16.9	5	nos.
9	CONCENTRIC REDUCER	CONC.REDUCER BW SCH80	DN50X40	ASTM A234 WPB	ASME B16.9	3	nos.
10	CONCENTRIC REDUCER	CONC.REDUCER BW SCH40	DN50X25	ASTM A234 WPB	ASME B16.9	4	nos.
11	CONCENTRIC REDUCER	CONC.REDUCER BW SCH40	DN40X32	ASTM A234 WPB	ASME B16.9	2	nos.
12	CONCENTRIC REDUCER	CONC.REDUCER BW SCH40	DN40X25	ASTM A234 WPB	ASME B16.9	5	nos.
13	CONCENTRIC REDUCER	CONC.REDUCER BW SCH80	DN40X25	ASTM A234 WPB	ASME B16.9	1	nos.
14	CONCENTRIC REDUCER	CONC.REDUCER BW SCH40	DN40X20	ASTM A234 WPB	ASME B16.9	2	nos.
15	CONCENTRIC REDUCER	CONC.REDUCER BW SCH40	DN32X25	ASTM A234 WPB	ASME B16.9	2	nos.
16	CONCENTRIC REDUCER	CONC.REDUCER BW SCH40	DN250X200	ASTM A234 WPB	ASME B16.9	4	nos.
17	CONCENTRIC REDUCER	CONC.REDUCER BW SCH40	DN200X150	ASTM A234 WPB	ASME B16.9	1	nos.
18	CONCENTRIC REDUCER	CONC.REDUCER BW SCH80	DN200X150	ASTM A234 WPB	ASME B16.9	1	nos.
19	CONCENTRIC REDUCER	CONC.REDUCER BW SCH80	DN150X80	ASTM A234 WPB	ASME B16.9	3	nos.
20	CONCENTRIC REDUCER	CONC.REDUCER BW SCH40	DN150X100	ASTM A234 WPB	ASME B16.9	1	nos.
21	CONCENTRIC REDUCER	CONC.REDUCER BW SCH80	DN150X100	ASTM A234 WPB	ASME B16.9	1	nos.
22	CONCENTRIC REDUCER	CONC.REDUCER BW SCH40	DN125X100	ASTM A234 WPB	ASME B16.9	1	nos.
23	CONCENTRIC REDUCER	CONC.REDUCER BW SCH40	DN100X80	ASTM A234 WPB	ASME B16.9	2	nos.
24	CONCENTRIC REDUCER	CONC.REDUCER BW SCH80	DN100X65	ASTM A234 WPB	ASME B16.9	4	nos.
25	ELBOW-45°	ELBOW LR 45 DEG SCH40	DN80	ASTM A234 WPB	ASME B16.9	17	nos.
26	ELBOW-45°	ELBOW LR 45 DEG SCH80	DN80	ASTM A234 WPB	ASME B16.9	24	nos.
27	ELBOW-45°	ELBOW LR 45 DEG SCH40	DN65	ASTM A234 WPB	ASME B16.9	17	nos.
28	ELBOW-45°	ELBOW LR 45 DEG SCH80	DN65	ASTM A234 WPB	ASME B16.9	45	nos.
29	ELBOW-45°	ELBOW LR 45 DEG SCH40	DN50	ASTM A234 WPB	ASME B16.9	75	nos.
30	ELBOW-45°	ELBOW LR 45 DEG SCH80	DN50	ASTM A234 WPB	ASME B16.9	60	nos.
31	ELBOW-45°	ELBOW LR 45 DEG SCH40	DN40	ASTM A234 WPB	ASME B16.9	31	nos.
32	ELBOW-45°	ELBOW LR 45 DEG SCH80	DN40	ASTM A234 WPB	ASME B16.9	14	nos.
33	ELBOW-45°	ELBOW LR 45 DEG SCH40	DN32	ASTM A234 WPB	ASME B16.9	10	nos.
34	ELBOW-45°	ELBOW LR 45 DEG SCH80	DN32	ASTM A234 WPB	ASME B16.9	8	nos.
35	ELBOW-45°	ELBOW LR 45 DEG SCH40	DN200	ASTM A234 WPB	ASME B16.9	3	nos.
36	ELBOW-45°	ELBOW LR 45 DEG SCH80	DN150	ASTM A234 WPB	ASME B16.9	4	nos.
37	ELBOW-45°	ELBOW LR 45 DEG SCH40	DN100	ASTM A234 WPB	ASME B16.9	4	nos.
38	ELBOW-45°	ELBOW LR 45 DEG SCH80	DN100	ASTM A234 WPB	ASME B16.9	12	nos.
39	ELBOW-90°	ELBOW LR 90 DEG SCH40	DN80	ASTM A234 WPB	ASME B16.9	127	nos.
40	ELBOW-90°	ELBOW LR 90 DEG SCH80	DN80	ASTM A234 WPB	ASME B16.9	85	nos.
41	ELBOW-90°	ELBOW LR 90 DEG SCH40	DN65	ASTM A234 WPB	ASME B16.9	50	nos.
42	ELBOW-90°	ELBOW LR 90 DEG SCH80	DN65	ASTM A234 WPB	ASME B16.9	115	nos.
43	ELBOW-90°	ELBOW LR 90 DEG SCH40	DN50	ASTM A234 WPB	ASME B16.9	195	nos.
44	ELBOW-90°	ELBOW LR 90 DEG SCH80	DN50	ASTM A234 WPB	ASME B16.9	185	nos.
45	ELBOW-90°	ELBOW LR 90 DEG SCH40	DN40	ASTM A234 WPB	ASME B16.9	60	nos.
46	ELBOW-90°	ELBOW LR 90 DEG SCH80	DN40	ASTM A234 WPB	ASME B16.9	138	nos.
47	ELBOW-90°	ELBOW LR 90 DEG SCH40	DN32	ASTM A234 WPB	ASME B16.9	40	nos.
48	ELBOW-90°	ELBOW LR 90 DEG SCH80	DN32	ASTM A234 WPB	ASME B16.9	35	nos.
49	ELBOW-90°	ELBOW LR 90 DEG SCH40	DN200	ASTM A234 WPB	ASME B16.9	10	nos.
50	ELBOW-90°	ELBOW LR 90 DEG SCH80	DN200	ASTM A234 WPB	ASME B16.9	3	nos.
51	ELBOW-90°	ELBOW SR 90 DEG SCH80	DN200	ASTM A234 WPB	ASME B16.9	6	nos.
52	ELBOW-90°	ELBOW LR 90 DEG SCH40	DN150	ASTM A234 WPB	ASME B16.9	2	nos.
53	ELBOW-90°	ELBOW LR 90 DEG SCH80	DN150	ASTM A234 WPB	ASME B16.9	5	nos.
54	ELBOW-90°	ELBOW SR 90 DEG SCH80	DN150	ASTM A234 WPB	ASME B16.9	8	nos.
55	ELBOW-90°	ELBOW LR 90 DEG SCH40	DN125	ASTM A234 WPB	ASME B16.9	14	nos.
56	ELBOW-90°	ELBOW LR 90 DEG SCH40	DN100	ASTM A234 WPB	ASME B16.9	12	nos.
57	ELBOW-90°	ELBOW LR 90 DEG SCH80	DN100	ASTM A234 WPB	ASME B16.9	17	nos.
58	PENETRATION SLEEVE	PIPE SMLS SCH160	DN80	ASTM A53 Gr B	ASME B36.10M	10	mtr
59	PENETRATION SLEEVE	PIPE SMLS SCH160	DN65	ASTM A53 Gr B	ASME B36.10M	10	mtr
60	PENETRATION SLEEVE	PIPE SMLS SCH160	DN50	ASTM A53 Gr B	ASME B36.10M	5	mtr
61	PENETRATION SLEEVE	PIPE SMLS SCH160	DN40	ASTM A53 Gr B	ASME B36.10M	5	mtr
62	PENETRATION SLEEVE	PIPE SMLS SCHXXS	DN40	ASTM A53 Gr B	ASME B36.10M	5	mtr
63	PENETRATION SLEEVE	PIPE SMLS SCH160	DN200	ASTM A53 Gr B	ASME B36.10M	5	mtr
64	PENETRATION SLEEVE	PIPE SMLS SCH120	DN125	ASTM A53 Gr B	ASME B36.10M	5	mtr
65	PENETRATION SLEEVE	PIPE SMLS SCH120	DN100	ASTM A53 Gr B	ASME B36.10M	10	mtr
66	PENETRATION SLEEVE	PIPE SMLS SCHXXS	DN100	ASTM A53 Gr B	ASME B36.10M	10	mtr
67	PIPE SMLS	PIPE SMLS SCH40	DN80	ASTM A53 Gr B	ASME B36.10M	144	mtr
68	PIPE SMLS	PIPE SMLS SCH80	DN80	ASTM A53 Gr B	ASME B36.10M	120	mtr
69	PIPE SMLS	PIPE SMLS SCH40	DN65	ASTM A53 Gr B	ASME B36.10M	91	mtr
70	PIPE SMLS	PIPE SMLS SCH80	DN65	ASTM A53 Gr B	ASME B36.10M	156	mtr
71	PIPE SMLS	PIPE SMLS SCH160	DN50	ASTM A53 Gr B	ASME B36.10M	5	mtr

72	PIPE SMLS	PIPE SMLS SCH40	DN50	ASTM A53 Gr B	ASME B36.10M	315	mtr
73	PIPE SMLS	PIPE SMLS SCH80	DN50	ASTM A53 Gr B	ASME B36.10M	160	mtr
74	PIPE SMLS	PIPE SMLS SCH40	DN40	ASTM A53 Gr B	ASME B36.10M	132	mtr
75	PIPE SMLS	PIPE SMLS SCH80	DN40	ASTM A53 Gr B	ASME B36.10M	185	mtr
76	PIPE SMLS	PIPE SMLS SCH40	DN32	ASTM A53 Gr B	ASME B36.10M	48	mtr
77	PIPE SMLS	PIPE SMLS SCH80	DN32	ASTM A53 Gr B	ASME B36.10M	60	mtr
78	PIPE SMLS	PIPE SMLS SCH40	DN200	ASTM A53 Gr B	ASME B36.10M	34	mtr
79	PIPE SMLS	PIPE SMLS SCH80	DN200	ASTM A53 Gr B	ASME B36.10M	15	mtr
80	PIPE SMLS	PIPE SMLS SCH80	DN150	ASTM A53 Gr B	ASME B36.10M	15	mtr
81	PIPE SMLS	PIPE SMLS SCH40	DN150	ASTM A53 Gr B	ASME B36.10M	10	mtr
82	PIPE SMLS	PIPE SMLS SCH40	DN125	ASTM A53 Gr B	ASME B36.10M	27	mtr
83	PIPE SMLS	PIPE SMLS SCH40	DN100	ASTM A53 Gr B	ASME B36.10M	15	mtr
84	PIPE SMLS	PIPE SMLS SCH80	DN100	ASTM A53 Gr B	ASME B36.10M	34	mtr
85	SLIP ON FLANGE	FLANGE SLIPON FF PN10	DN80	IS 2062 Gr B	EN1092-1	210	nos.
86	SLIP ON FLANGE	FLANGE SLIPON FF PN16	DN80	IS 2062 Gr B	EN1092-1	42	nos.
87	SLIP ON FLANGE	FLANGE SLIPON FF PN10	DN65	IS 2062 Gr B	EN1092-1	360	nos.
88	SLIP ON FLANGE	FLANGE SLIPON FF PN10	DN50	IS 2062 Gr B	EN1092-1	730	nos.
89	SLIP ON FLANGE	FLANGE SLIPON FF PN16	DN50	IS 2062 Gr B	EN1092-1	46	nos.
90	SLIP ON FLANGE	FLANGE SLIPON FF PN10	DN40	IS 2062 Gr B	EN1092-1	327	nos.
91	SLIP ON FLANGE	FLANGE SLIPON FF PN16	DN40	IS 2062 Gr B	EN1092-1	16	nos.
92	SLIP ON FLANGE	FLANGE SLIPON FF PN10	DN32	IS 2062 Gr B	EN1092-1	190	nos.
93	SLIP ON FLANGE	FLANGE SLIPON FF PN10	DN200	IS 2062 Gr B	EN1092-1	44	nos.
94	SLIP ON FLANGE	FLANGE SLIPON FF PN16	DN200	IS 2062 Gr B	EN1092-1	2	nos.
95	SLIP ON FLANGE	FLANGE SLIPON FF PN10	DN150	IS 2062 Gr B	EN1092-1	6	nos.
96	SLIP ON FLANGE	FLANGE SLIPON FF PN16	DN150	IS 2062 Gr B	EN1092-1	18	nos.
97	SLIP ON FLANGE	FLANGE SLIPON FF PN10	DN125	IS 2062 Gr B	EN1092-1	38	nos.
98	SLIP ON FLANGE	FLANGE SLIPON FF PN10	DN100	IS 2062 Gr B	EN1092-1	58	nos.
99	CONCENTRIC REDUCER	CONC.REDUCER BW SCH40	DN25X15	ASTM A234 WPB	ASME B16.9	7	nos.
100	CONCENTRIC REDUCER	CONC.REDUCER BW SCH80	DN25X20	ASTM A234 WPB	ASME B16.9	4	nos.
101	ELBOW-45°	ELBOW LR 45 DEG SCH80	DN25	ASTM A234 WPB	ASME B16.9	11	nos.
103	ELBOW-90°	ELBOW LR 90 DEG SCH80	DN 25	ASTM A234 Gr. WP	ASME B16.9	4	Nos.
104	ELBOW-90°	ELBOW LR 90 DEG SCH80	DN 20	ASTM A234 Gr. WP	ASME B16.9	9	Nos.
105	ELBOW-90°	ELBOW LR 45 DEG SCH80	DN 20	ASTM A234 Gr. WP	ASME B16.9	5	Nos.
106	PIPE SMLS	TUBE 1.5THK	Ø8	ASTM A192 Gr B	ASME B36.10M	45	mtr
107	PIPE SMLS	PIPE SMLS SCH40	DN25	ASTM A53 Gr B	ASME B36.10M	123	mtr
108	PIPE SMLS	PIPE SMLS SCH80	DN25	ASTM A53 Gr B	ASME B36.10M	88	mtr
109	PIPE SMLS	PIPE SMLS SCH40	DN20	ASTM A53 Gr B	ASME B36.10M	57	mtr
110	PIPE SMLS	PIPE SMLS SCH80	DN20	ASTM A53 Gr B	ASME B36.10M	51	mtr
111	PIPE SMLS	PIPE SMLS SCH40	DN15	ASTM A53 Gr B	ASME B36.10M	87	mtr
112	PIPE SMLS	PIPE SMLS SCH80	DN15	ASTM A53 Gr B	ASME B36.10M	14	mtr
113	SLIP ON FLANGE	FLANGE SLIPON FF PN10	DN25	IS 2062 Gr B	EN1092-1	100	nos.
114	SLIP ON FLANGE	FLANGE SLIPON FF PN16	DN25	IS 2062 Gr B	EN1092-1	1	nos.
115	SLIP ON FLANGE	FLANGE SLIPON FF PN10	DN20	IS 2062 Gr B	EN1092-1	40	nos.
116	SLIP ON FLANGE	FLANGE SLIPON FF PN10	DN15	IS 2062 Gr B	EN1092-1	30	nos.
117	SOCKET WELDED MALE NPT NIPPLE	SOCKET WELDED MALE NPT NIPPLE 3000#	DN25	SA 105	ASME B16.11	12	nos.
118	SOCKET WELDED MALE NPT NIPPLE	SOCKET WELDED MALE NPT NIPPLE 3000#	DN20	SA 105	ASME B16.11	8	nos.
119	SOCKET WELDED MALE NPT NIPPLE	SOCKET WELDED MALE NPT NIPPLE 3000#	DN15	SA 105	ASME B16.11	28	nos.
120	SOCKETWELDED COUPLING	SOCKETWELDED COUPLING 3000#	DN25	SA 105	ASME B16.11	81	nos.
121	SOCKETWELDED COUPLING	SOCKETWELDED COUPLING 3000#	DN20	SA 105	ASME B16.11	48	nos.
122	SOCKETWELDED COUPLING	SOCKETWELDED COUPLING 3000#	DN15	SA 105	ASME B16.11	64	nos.
123	SLIP ON FLANGE	FLANGE SLIPON FF PN10	DN400	IS 2062 Gr B	EN1092-1	9	nos.
124	SLIP ON FLANGE	FLANGE SLIPON FF PN16	DN300	IS 2062 Gr B	EN1092-1	3	nos.
125	PIPE SMLS	PIPE SMLS SCH80	DN550	ASTM A53 Gr B	ASME B36.10M	3	mtr
126	PIPE SMLS	PIPE SMLS SCH80	DN450	ASTM A53 Gr B	ASME B36.10M	8	mtr
127	PIPE SMLS	PIPE SMLS SCH80	DN400	ASTM A53 Gr B	ASME B36.10M	2	mtr
128	PIPE SMLS	PIPE SMLS SCH20	DN400	ASTM A53 Gr B	ASME B36.10M	20	mtr
129	PIPE SMLS	PIPE SMLS SCH80	DN350	ASTM A53 Gr B	ASME B36.10M	20	mtr
130	PIPE SMLS	PIPE SMLS SCH80	DN300	ASTM A53 Gr B	ASME B36.10M	2	mtr
102	ELBOW-45°	ELBOW LR 45 DEG SCH20	DN400	ASTM A234 WPB	ASME B16.9	4	nos.
131	ELBOW-90°	ELBOW SR 90 DEG SCH80	DN450	ASTM A234 WPB	ASME B16.9	1	nos.
132	ELBOW-90°	ELBOW LR 90 DEG SCH20	DN400	ASTM A234 WPB	ASME B16.9	3	nos.
133	ELBOW-90°	ELBOW SR 90 DEG SCH80	DN400	ASTM A234 WPB	ASME B16.9	1	nos.
134	ELBOW-90°	ELBOW LR 90 DEG SCH80	DN350	ASTM A234 WPB	ASME B16.9	5	nos.
135	ELBOW-90°	ELBOW SR 90 DEG SCH80	DN350	ASTM A234 WPB	ASME B16.9	10	nos.
136	ELBOW-90°	ELBOW SR 90 DEG SCH80	DN300	ASTM A234 WPB	ASME B16.9	2	nos.
137	PENETRATION SLEEVE	PIPE SMLS SCH80	DN400	ASTM A53 Gr B	ASME B36.10M	2	mtr
138	CONCENTRIC REDUCER	CONC.REDUCER BW SCH80	DN550X400	ASTM A234 WPB	ASME B16.9	1	nos.
139	CONCENTRIC REDUCER	CONC.REDUCER BW SCH80	DN450X350	ASTM A234 WPB	ASME B16.9	2	nos.
140	CONCENTRIC REDUCER	CONC.REDUCER BW SCH80	DN450X300	ASTM A234 WPB	ASME B16.9	1	nos.
141	CONCENTRIC REDUCER	CONC.REDUCER BW SCH80	DN350X200	ASTM A234 WPB	ASME B16.9	2	nos.

<b>STAINLESS STEEL PIPING - CONSOLIDATED MATERIAL SUMMARY</b>							
<b>Sl. No.</b>	<b>Item Type</b>	<b>Description</b>	<b>Size / Dimensions</b>	<b>Material</b>	<b>Standard</b>	<b>Total Req. Per Ship</b>	<b>UOM</b>
1	PIPE SMLS	PIPE SMLS SCH40S	DN25	A312, SS316L	A312, SS316L	10	mtr
2	PIPE SMLS	PIPE SMLS SCH40S	DN40	A312, SS316L	A312, SS316L	10	mtr
3	PIPE SMLS	PIPE SMLS SCH40S	DN50	A312, SS316L	A312, SS316L	27	mtr
4	PIPE SMLS	PIPE SMLS SCH40S	DN65	A312, SS316L	A312, SS316L	27	mtr
5	PENETRATION SLEEVE	PIPE SMLS SCH160S	DN40	A312, SS316L	A312, SS316L	2.5	mtr
6	PENETRATION SLEEVE	PIPE SMLS SCH160S	DN65	A312, SS316L	A312, SS316L	2.5	mtr
7	PENETRATION SLEEVE	PIPE SMLS SCH160S	DN80	A312, SS316L	A312, SS316L	2.5	mtr
8	PENETRATION SLEEVE	PIPE SMLS SCHXXS	DN100	A312, SS316L	A312, SS316L	2.5	mtr
9	ELBOW-90°	ELBOW LR 90 DEG SCH40S	DN50	A403, WP304	A403, WP304	16	nos.
10	ELBOW-90°	ELBOW LR 90 DEG SCH40S	DN65	A403, WP304	A403, WP304	15	nos.
11	ELBOW-45°	ELBOW LR 45 DEG SCH40S	DN50	A403, WP304	A403, WP304	8	nos.
12	ELBOW-45°	ELBOW LR 45 DEG SCH40S	DN65	A403, WP304	A403, WP304	5	nos.
13	SOCKETWELDED COUPLING	SOCKETWELDED COUPLING 3000#	DN25	A182, SS304L	A182, SS304L	8	nos.
14	CONCENTRIC REDUCER	CONC.REDUCER BW SCH40S	DN40X25	A403, WP304	A403, WP304	2	nos.
15	FLANGE	FLANGE SLIPON FF PN10	DN25	A182, Gr F.304	A182, Gr F.304	18	nos.
16	FLANGE	FLANGE SLIPON FF PN10	DN40	A182, Gr F.304	A182, Gr F.304	10	nos.
17	FLANGE	FLANGE SLIPON FF PN10	DN50	A182, Gr F.304	A182, Gr F.304	54	nos.
18	FLANGE	FLANGE SLIPON FF PN10	DN65	A182, Gr F.304	A182, Gr F.304	50	nos.

<b>CLASS APPROVED PIPING - CONSOLIDATED MATERIAL SUMMARY</b>							
<b>Sl. No.</b>	<b>Item Type</b>	<b>Description</b>	<b>Size / Dimensions</b>	<b>Material</b>	<b>Standard</b>	<b>Total Req. Per Ship</b>	<b>UOM</b>
1	PIPE - ASTM A106 Gr B	PIPE SMLS SCH 160	DN80	ASTM A106 Gr B	ASME B36.10M	1.5	mtr
2	PIPE - ASTM A106 Gr B	PIPE SMLS SCH 80	DN400	ASTM A106 Gr B	ASME B36.10M	1.5	mtr
3	PIPE - ASTM A106 Gr B	PIPE SMLS SCH 80	DN550	ASTM A106 Gr B	ASME B36.10M	1.5	mtr
4	PIPE - ASTM A53 Gr B	PIPE SMLS SCH80	DN15	ASTM A53 Gr B	ASME B36.10M	1.5	mtr
5	PIPE - ASTM A53 Gr B	PIPE SMLS SCHXXS	DN40	ASTM A53 Gr B	ASME B36.10M	1.5	mtr
6	PIPE - ASTM A53 Gr B	PIPE SMLS SCH80	DN50	ASTM A53 Gr B	ASME B36.10M	1.5	mtr
7	PIPE - ASTM A53 Gr B	PIPE SMLS SCHXXS	DN50	ASTM A53 Gr B	ASME B36.10M	4.5	mtr
8	PIPE - ASTM A53 Gr B	PIPE SMLS SCHXXS	DN65	ASTM A53 Gr B	ASME B36.10M	1.5	mtr
9	PIPE - ASTM A53 Gr B	PIPE SMLS SCH160	DN80	ASTM A53 Gr B	ASME B36.10M	3	mtr
10	PIPE - ASTM A53 Gr B	PIPE SMLS SCH100	DN200	ASTM A53 Gr B	ASME B36.10M	4.5	mtr

Encl. 2 Valve and fittings

**List of Valves to be fitted during fitment of pipe spools.**

<b>40 T BP TUG_VALVE DETAILS (IRS APPROVED) FOR 01 VESSEL</b>									
Sr. No	Type	Size	End Connection	Body Material	Class	Pr. Rating	IRS Approval	FTF	Qty/ Vessel
		(NB)							(Nos.)
1	GLOBE	50	Flange	Cast Steel	III	PN10	IRS Unit Approval	230	3
2	SDNR	15	Flange	Cast Steel	III	PN10	IRS Unit Approval	130	3
3	SDNR	40	Flange	Cast Steel	III	PN10	IRS Unit Approval	200	1
4	SDNR	50	Flange	Cast Steel	III	PN10	IRS Unit Approval	230	4
5	SDNR	65	Flange	Cast Steel	III	PN10	IRS Unit Approval	290	1
6	SDNR	80	Flange	Cast Steel	III	PN10	IRS Unit Approval	310	4
7	SDNR	80	Flange	Cast Steel	III	PN16	IRS Unit Approval	310	1
8	ANGLE GLOBE	200	Flange	Cast Steel	III	PN10	IRS Unit Approval	275	2
9	GATE	50	Flange	Cast Steel	III	PN10	IRS Unit Approval	180	2
10	HYDRANT	65	Flange	Bronze	III	PN10	IRS/MMD Type Approval	-	13
11	STROM VALVE	50	Flange	Cast Steel	III	PN10	IRS Unit Approval	-	2
12	STROM VALVE	80	Flange	Cast Steel	III	PN10	IRS Unit Approval	-	1
<b>40 T BP TUG_VALVE DETAILS (NON-CLASS) FOR 01 VESSEL</b>									
Sr. No	Type	Size (NB)	Pr. Rating	Class	End Connection	Fluid	Body Material	FTF	Qty/ Vessel (Nos.)
1	BALL VALVE	40	PN10	III	Flange	Portable Water	Nodular Cast Iron	140	2
2	BALL VALVE	50	PN10	III	Flange	Portable Water	Nodular Cast Iron	150	2
3	SDNR VALVE	50	PN10	III	Flange	Bilge Water/Sea Water	Nodular Cast Iron	230	2
4	SDNR VALVE	65	PN10	III	Flange	Bilge Water/Sea Water	Nodular Cast Iron	290	5
5	GATE VALVE	65	PN10	III	Flange	Bilge Water/Sea Water	Cast Steel	170	4
6	GATE VALVE	65	PN10	III	Flange	Bilge Water/Sea Water	Nodular Cast Iron	170	1
7	GATE VALVE	32	PN10	III	Flange	Sea Water	Cast Steel	130	3
8	GATE VALVE	25	PN10	III	Flange	Sea Water	Cast Steel	125	2
9	GATE VALVE	50	PN10	III	Flange	Sea Water	Cast Steel	150	4
10	SDNR VALVE	100	PN10	III	Flange	Bilge Water/Sea Water	Cast Steel	350	1
11	SDNR VALVE	65	PN10	III	Flange	Bilge Water/Sea Water	Cast Steel	290	2
12	BALL VALVE	25	PN10	III	Flange	Fuel Oil	Nodular Cast Iron	125	8
13	GATE VALVE	80	PN10	III	Flange	Fuel Oil	Cast Steel	180	2
14	PRESSURE RELIEF (2.8 BAR)	80	PN10	III	Flange	Fuel Oil	Nodular Cast Iron	-	1
15	GATE VALVE	50	PN10	III	Flange	Fuel Oil	Nodular Cast Iron	150	20
16	SDNR VALVE	50	PN10	III	Flange	Fuel Oil	Nodular Cast Iron	230	2
17	QUICK CLOSING VALVE	50	PN10	III	Flange	Fuel Oil	Nodular Cast Iron	-	4
18	GATE VALVE	15	PN10	III	Socket weld	Fuel Oil	Nodular Cast Iron	-	1
19	QUICK CLOSING VALVE	40	PN10	III	Flange	Fuel Oil	Nodular Cast Iron	-	2
20	BALL VALVE	40	PN10	III	Flange	Fuel Oil	Nodular Cast Iron	140	1
21	GLOBE VALVE (WITH SPRING OPERATOR)	20	PN10	III	Flange	Fuel Oil	Nodular Cast Iron	-	2

22	BALL VALVE	15	PN10	III	Socket weld	Fuel Oil	Nodular Cast Iron		1
23	BALL VALVE	15	PN10	III	Threaded	Fuel Oil	Nodular Cast Iron		1
24	SWING CHECK VALVE (THREADED ENDS)	15	PN10	III	Threaded	Fuel Oil	Nodular Cast Iron	60	2
25	SWING CHECK VALVE (THREADED ENDS)	8mm	PN10	III	Threaded	Fuel Oil	Nodular Cast Iron	60	2
26	BALL VALVE	32	PN10	III	Flange	Fuel Oil	Nodular Cast Iron	130	3
27	GATE VALVE	50	PN10	III	Flange	Fresh Water	Nodular Cast Iron	150	4
28	BALL VALVE	50	PN10	III	Flange	Fresh Water	Nodular Cast Iron	150	2
29	BUTTERFLY VALVE	50	PN10	III	Lug type	Fresh Water	Nodular Cast Iron	43	6
30	BALL VALVE	50	PN16	III	Flange	Sea Water	Cast Steel	150	1
31	BUTTERFLY VALVE	150	PN16	III	Lug type	Sea Water	Cast Steel	56	3
32	SWING CHECK VALVE (SHORT TYPE)	150	PN16	III	Flange	Sea Water	Cast Steel	200	1
33	SWING CHECK VALVE (SHORT TYPE)	80	PN16	III	Flange	Sea Water	Cast Steel	125	1
34	BUTTERFLY VALVE	80	PN16	III	Lug type	Sea Water	Cast Steel	46	3
35	BALL VALVE	25	PN16	III	Flange	Sea Water	Cast Steel	125	1
36	BUTTERFLY VALVE	200	PN10	III	Lug type	Sea Water	Cast Steel	60	3
37	BUTTERFLY VALVE	65	PN10	III	Lug type	Sea Water	Cast Steel	46	5
38	BUTTERFLY VALVE	50	PN10	III	Lug type	Sea Water	Cast Steel	43	7
39	BUTTERFLY VALVE	100	PN10	III	Lug type	Sea Water	Cast Steel	52	2
40	BUTTERFLY VALVE	40	PN10	III	Lug type	Sea Water	Cast Steel	33	1
41	DUAL PLATE CHECK VALVE	65	PN10	III	Flange	Sea Water	Cast Steel	54	1
42	BALL VALVE	40	PN10	III	Flange	Sea Water	Cast Steel	140	10
43	GLOBE VALVE	40	PN10	III	Flange	Sea Water	Cast Steel	200	3
44	BALL VALVE	32	PN10	III	Flange	Sea Water	Cast Steel	130	1
45	GLOBE VALVE	32	PN10	III	Flange	Sea Water	Cast Steel	180	1
46	BALL VALVE	20	PN10	III	Flange	Sea Water	Cast Steel	120	2
47	GLOBE VALVE	20	PN10	III	Flange	Sea Water	Cast Steel	150	2
48	BUTTERFLY VALVE	80	PN10	III	Lug type	Sea Water	Cast Steel	46	2
49	BUTTERFLY VALVE	65	PN10	III	Lug type	Fresh Water	Nodular Cast Iron	46	6
50	BALL VALVE	20	PN10	III	Flange	Fresh Water	Nodular Cast Iron	120	4
51	BALL VALVE	15	PN10	III	Threaded	Fresh Water	Nodular Cast Iron	64.7	3
52	BALL VALVE	25	PN10	III	Flange	Fresh Water	Nodular Cast Iron	125	2
53	BALL VALVE	40	PN10	III	Flange	Fresh Water	Nodular Cast Iron	140	12
54	GLOBE VALVE (WITH SPRING OPERATOR)	25	PN10	III	Flange	Lube oil	Nodular Cast Iron	160	1
55	GLOBE VALVE	25	PN10	III	Flange	Lube oil	Nodular Cast Iron	160	2
56	BALL VALVE	25	PN10	III	Flange	Lube oil	Nodular Cast Iron	125	9
57	GLOBE VALVE	40	PN10	III	Flange	Lube oil	Nodular Cast Iron	200	2
58	GLOBE VALVE	80	PN10	III	Flange	Lube oil	Nodular Cast Iron	310	2
59	GLOBE VALVE	15	PN10	III	Flange	Lube oil	Nodular Cast Iron	130	2
60	SDNR VALVE	80	PN10	III	Flange	Lube oil	Nodular Cast Iron	310	2
61	BALL VALVE	15	PN10	III	Threaded	Lube oil	Nodular Cast Iron	-	8
62	BALL VALVE	65	PN10	III	Flange	Oily water	Nodular Cast Iron	170	1
63	BALL VALVE	40	PN10	III	Flange	Oily water	Nodular Cast Iron	140	6

64	GLOBE VALVE-WEIGHTED CLOSE	25	PN10	III	Flange	Oily water	Nodular Cast Iron	160	1
65	SWING CHECK VALVE (SHORT TYPE)	25	PN10	III	Flange	Oily water	Nodular Cast Iron	70	1
66	BALL VALVE	25	PN10	III	Threaded	Oily water	Nodular Cast Iron	-	3
67	BALL VALVE	40	PN10	III	Flange	Sludge	Nodular Cast Iron	140	5
68	SWING CHECK VALVE (SHORT TYPE)	40	PN10	III	Flange	Oily water	Nodular Cast Iron	80	1
69	SDNR VALVE	40	PN10	III	Flange	Oily water	Nodular Cast Iron	200	1
70	SWING CHECK VALVE (SHORT TYPE)	25	PN10	III	Threaded	Oily water	Nodular Cast Iron	70	1
71	SWING CHECK VALVE (SHORT TYPE)	25	PN10	III	Flange	Sludge	Nodular Cast Iron	70	2
72	SWING CHECK VALVE (SHORT TYPE)	20	PN10	III	Flange	Sludge	Nodular Cast Iron	65	1
73	GLOBE VALVE-WEIGHTED CLOSE	25	PN10	III	Flange	Sludge	Nodular Cast Iron	160	1
74	GLOBE VALVE	25	PN10	III	Flange	Sludge	Nodular Cast Iron	160	1
75	SWING CHECK VALVE (SHORT TYPE)	40	PN10	III	Flange	Sludge	Nodular Cast Iron	80	1
76	SDNR VALVE	25	PN10	III	Flange	Dispersant	Bronze	160	2
77	BALL VALVE	25	PN10	III	Flange	Dispersant	Stainless steel	125	3
78	BALL VALVE	25	PN40	III	Flange	Air	Nodular Cast Iron	125	4
79	SWING CHECK VALVE (SHORT TYPE)	25	PN40	III	Flange	Air	Nodular Cast Iron	70	2
80	BALL VALVE	10	PN40	III	Threaded	Air	Nodular Cast Iron		2
81	SDNR VALVE	40	PN40	III	Flange	Air	Nodular Cast Iron	200	2
82	BALL VALVE	8mm	PN40	III	Threaded	Air	Cast steel		12
83	BALL VALVE	25	PN10	III	Flange	Air	Nodular Cast Iron	125	11
84	BALL VALVE	15	PN10	III	Flange	Air	Nodular Cast Iron	115	8
85	PRESSURE RELIEF (7.7 BAR)	25	PN10	III	Flange	Air	Nodular Cast Iron	-	1
86	PRESSURE REDUCING, (7 BAR - 30 BAR)	25	PN10	III	Flange	Air	Nodular Cast Iron	-	2
87	PRESSURE RELIEF (1.1 BAR)	25	PN10	III	Flange	Air	Nodular Cast Iron	-	1
88	PRESSURE REDUCING, (1 BAR - 7 BAR)	25	PN10	III	Flange	Air	Nodular Cast Iron	-	2
89	BALL VALVE	25	PN10	III	Threaded	Fresh Water	Nodular Cast Iron	84.8	2
90	SWING CHECK VALVE (SHORT TYPE)	40	PN10	III	Flange	Fresh Water	Nodular Cast Iron	80	2
91	GLOBE VALVE	40	PN10	III	Flange	Fresh Water	Nodular Cast Iron	200	2
92	SDNR VALVE	40	PN10	III	Flange	Sea Water	Cast Steel	200	2
93	PRESSURE RELIEF VALVE (3.9 BAR)	40	PN10	III	Flange	Fresh Water	Nodular Cast Iron	-	2
94	GATE VALVE	100	PN10	III	Flange	Black water	Cast Steel	170	2
95	DUAL PLATE CHECK VALVE	100	PN10	III	Flange	Black water	Cast Steel	64	1
96	DUAL PLATE CHECK VALVE	50	PN10	III	Flange	Black water	Cast Steel	54	1
97	BALL VALVE	50	PN10	III	Flange	Black water	Cast Steel	150	2
98	GATE VALVE	50	PN10	III	Flange	Black water	Cast Steel	150	5
99	SDNR VALVE	50	PN10	III	Flange	Black water	Cast Steel	230	1
100	GATE VALVE	80	PN10	III	Flange	Grey water	Cast Steel	180	3
101	DUAL PLATE CHECK VALVE	80	PN10	III	Flange	Grey water	Cast Steel	54	1
102	GATE VALVE	50	PN10	III	Flange	Grey water	Cast Steel	150	1
103	BALL VALVE	20	PN10	III	Threaded	Drain water	Cast Steel	73.4	4

**BOM of Pipe Supports to be fabricated and fitted during fitment of pipe spools.**

SUPPORT MEMBER					
SL.NO.	TYPE	SIZE	TOTAL LENGTH(m)	QTY.	WEIGHT(kg)
1	L ANGLE	L 75x75x6	3383	-	23174
2	L ANGLE	L 50x50x6	12	-	54
3	FLAT BAR	50x8	1173	-	2762
4	FLAT BAR	60x10	3	-	14
5	FLAT BAR	75x10	5	-	29
6	FLAT BAR	100x10	24	-	188
7	DOUBLER PLATE	100x100x10	-	272	214


U BOLT					
SL.NO.	PIPE SIZE	U BOLT SIZE	U BOLT QTY.	NUT QTY.	WASHER QTY.
1	DN15	M6	1	4	2
2	DN25	M6	20	80	40
3	DN32	M10	2	8	4
4	DN40	M10	28	112	56
5	DN50	M10	89	356	178
6	DN65	M12	40	164	80
7	DN80	M12	26	114	52
8	DN100	M12	3	12	6

U CLAMP						
SL.NO.	PIPE SIZE	U CLAMP QTY.	BOLT SIZE	BOLT QTY.	NUT QTY.	WASHER QTY.
1	Ø10	8	M6	8	8	8
2	DN15	18	M6	18	18	18
3	DN20	10	M6	10	10	10
4	DN25	38	M6	38	38	38
5	DN32	16	M10	16	16	16
6	DN40	92	M10	92	92	92
7	DN50	78	M10	78	78	78
8	DN65	60	M12	60	60	60
9	DN80	56	M12	56	56	56
10	DN100	4	M12	4	4	4
11	DN200	2	M16	2	2	2
12	DN350	12	M16	12	12	12



**Pipe Support Sample Drawings: -**

**GOAL POST SUPPORT (GP-01)**

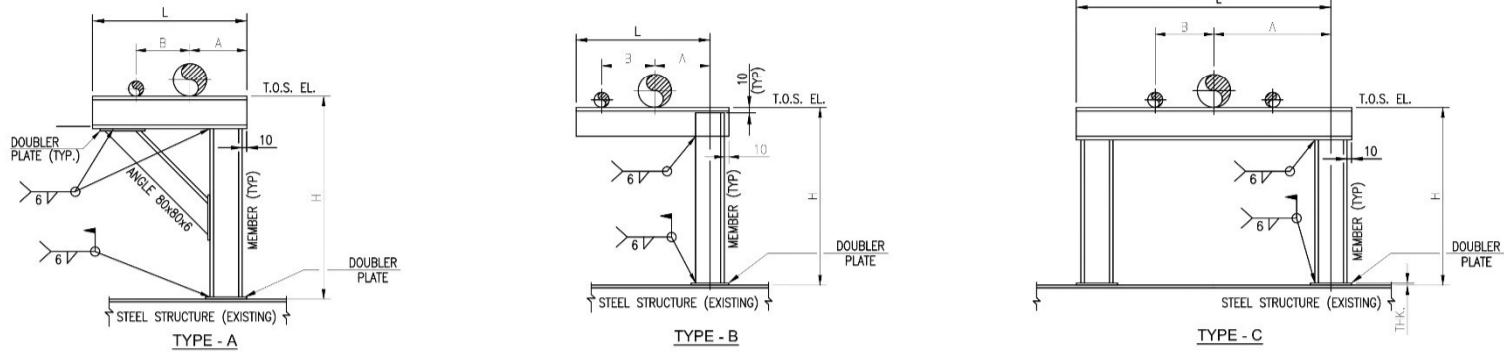

**NOTES**

1. MAXIMUM DIMENSION OF SUPPORT AND LOAD GIVEN IN THE TABLE FOR GUIDANCE ONLY. FOR LOWER LOAD MAXIMUM DIMENSION CAN BE INCREASED PROPORTIONATE TO THE MAXIMUM ALLOWABLE LOAD.
2. ALL SHARP CORNERS SHALL BE ROUNDED OFF.
3. DOUBLER PLATE IS APPLICABLE ONLY WHEN SUPPORT IS WELDED ON BULKHEAD.
4. FOR DOUBLER PLATE, REFER STANDARD DP01
5. DIMENSIONS A, B TO BE FOLLOWED AS PER PIPING GA

REF.	SUPPORT MEMBER SIZE	H (MAX.) NOTE 1	L (MAX.) NOTE 1	MAX. LOAD IN KG.
1	ANGLE 100x100x10	750mm	500mm	610
2	ANGLE 80x80x8	500mm	300mm	250
3	ANGLE 80x80x6	500mm	300mm	230
4	UPN-100x50x10.6	750mm	500mm	1525
5	CHANNEL 152x76x18	1000mm	600mm	2030
6	CHANNEL 203x76x24	2500mm	1500mm	1020

ITEM NO.	DESCRIPTION	MATERIAL
1	STEEL/PROFILE	ASTM A36
2	PLATE	ASTM A36

ONLY FOR REFERENCE

All dimensions in mm unless noted otherwise; Do not scale the drawing



**S&O MARITIME SERVICES PVT. LTD.**

Cheriyappalassery  
Mekkad PO, Nedumbassery (NH-544)  
Ernakulam 683589, Kerala, India  
E-mail : info@SandOmaritime.com, Web : www.SandOmaritime.com

This drawing or document is the property of S&O Maritime Services Pvt. Ltd. and must in no case wholly or partially be copied, shown or given to a third party without the expressed consent of S&O Maritime Services Pvt. Ltd.

Rev	Date	Drawn	Checked	Revision Subject
---	---	---	---	---


Client: ---

Project / Vessel: ---

Drawing Name: **STANDARD SUPPORT DRAWING**

Drawing No: ---	Rev: ---	Sheet: <b>10 OF 10</b>	Scale: <b>1:1</b>	Size: <b>A3</b>
-----------------	----------	------------------------	-------------------	-----------------

**DOUBLER PLATE (DP-01)**

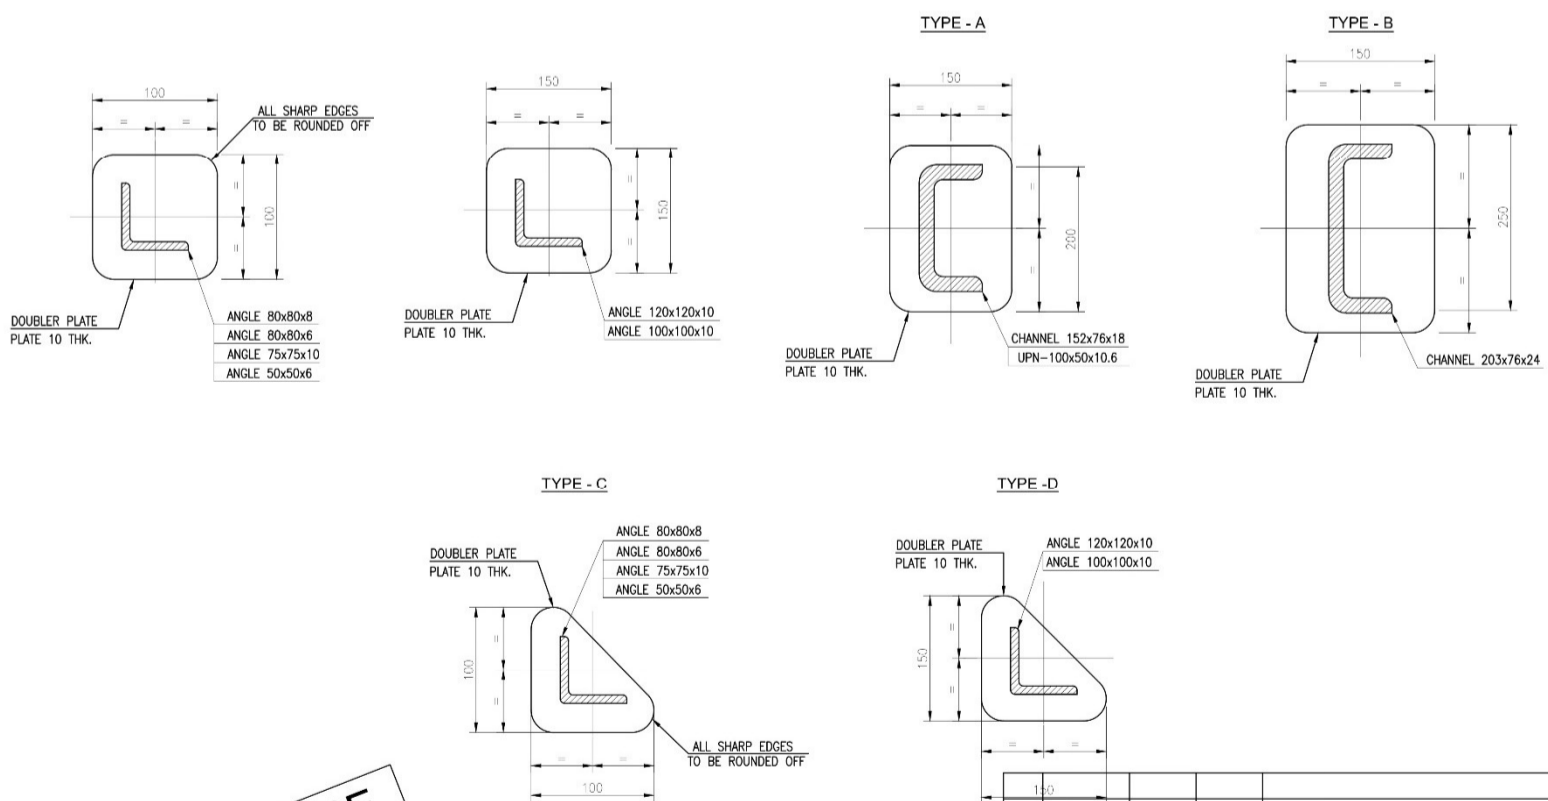

All dimensions in mm unless noted otherwise; Do not scale the drawing



**S&O MARITIME SERVICES PVT. LTD.**

Cheriyappalassery  
Mekkad PO, Nedumbassery (NH-544)  
Ernakulam 683589, Kerala, India  
E-mail : info@SandOmaritime.com, Web : www.SandOmaritime.com

This drawing or document is the property of S&O Maritime Services Pvt. Ltd. and must in no case wholly or partially be copied, shown or given to a third party without the expressed consent of S&O Maritime Services Pvt. Ltd.

Rev	Date	Drawn	Checked	Revision Subject
---	---	---	---	---

Client: ---


Project / Vessel: ---

Drawing Name: **STANDARD SUPPORT DRAWING**

Drawing No: ---	Rev: ---	Sheet: <b>9 OF 10</b>	Scale: <b>1:1</b>	Size: <b>A3</b>
-----------------	----------	-----------------------	-------------------	-----------------

ONLY FOR REFERENCE

## T-POST SUPPORT-1 (TP-01)

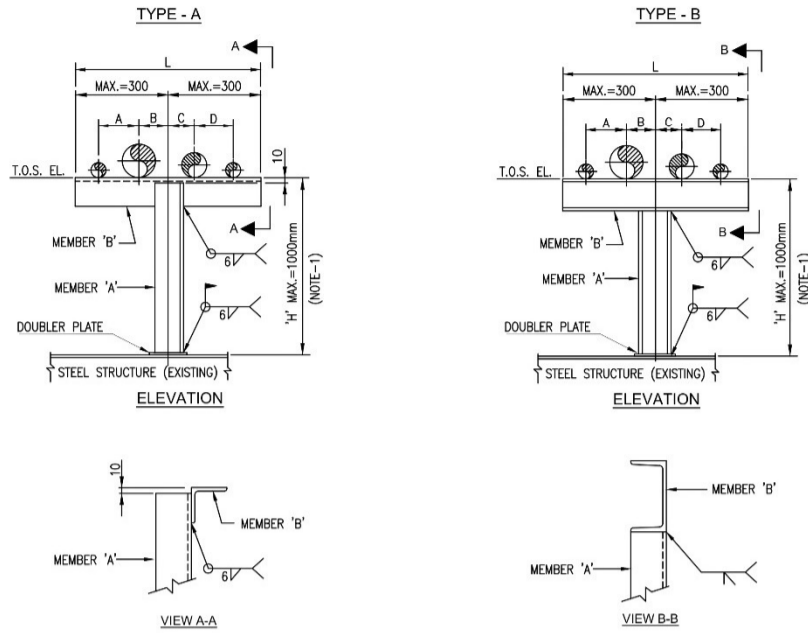

ITEM NO.	DESCRIPTION	MATERIAL
1	STEEL/PROFILE	ASTM A36
2	PLATE	ASTM A36

REF.	SUPPORT MEMBER		MAX. LOAD IN KG.
	MEMBER 'A'	MEMBER 'B'	
1	ANGLE 80x80x8	ANGLE 80x80x8	305
2	ANGLE 120x120x10	ANGLE 100x100x10	760
3	CHANNEL 152x76x18	CHANNEL 152x76x18	510

**NOTES**

1. MAXIMUM DIMENSION OF SUPPORT AND LOAD GIVEN IN THE TABLE FOR GUIDANCE ONLY. FOR LOWER LOAD MAXIMUM DIMENSION CAN BE INCREASED PROPORTIONATE TO THE MAXIMUM ALLOWABLE LOAD.
2. ALL SHARP CORNERS SHALL BE ROUNDED OFF.
3. DOUBLER PLATE IS APPLICABLE ONLY WHEN SUPPORT IS WELDED ON BULKHEAD.
4. FOR DOUBLER PLATE, REFER STANDARD DP01
5. DIMENSIONS A, B, C, D TO BE FOLLOWED AS PER PIPING GA

ONLY FOR REFERENCE

All dimensions in mm unless noted otherwise; Do not scale the drawing

**S&O MARITIME SERVICES PVT. LTD.**


Cheriya Vappalassery  
Mekkad PO, Nedumbassery (NH-544)  
Ernakulam 683589, Kerala, India  
E-mail : info@SandOmaritime.com, Web : www.SandOmaritime.com

This drawing or document is the property of S&O Maritime Services Pvt. Ltd. and must in no case wholly or partially be copied, shown or given to a third party without the expressed consent of S&O Maritime Services Pvt. Ltd.

Rev	Date	Drawn	Checked	Revision	Subject

Client					---
Project / Vessel					---
Drawing Name					STANDARD SUPPORT DRAWING
Drawing No:	Rev	Sheet	Scale	Size	
---	---	8 OF 10	1:1	A3	

### HANGER REVERSE 'T' TYPE SUPPORT (HS-02)

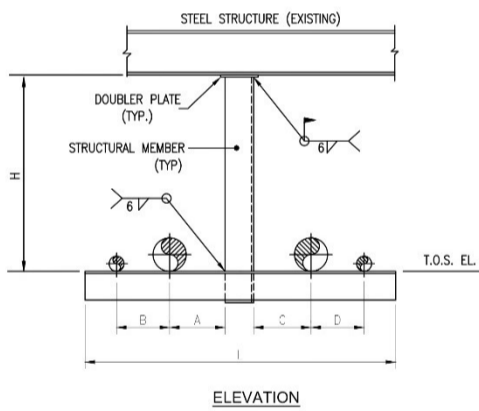

ITEM NO.	DESCRIPTION	MATERIAL
1	PLATE	ASTM A36
2	ANGLE	ASTM A36

MEMBER SIZE REF.	SIZE OF STRUCTURAL MEMBER	MAX. HEIGHT 'H' (NOTE-1)	MAX. LENGTH 'L' (NOTE-1)	MAX. LOAD IN KG
1	ANGLE 80x80x8	500mm	300mm	300
2	ANGLE 100x100x10	750mm	500mm	400
3	CHANNEL 152x76x18	1000mm	600mm	500

**NOTES**

1. MAXIMUM DIMENSION OF SUPPORT AND LOAD GIVEN IN THE TABLE FOR GUIDANCE ONLY. FOR LOWER LOAD MAXIMUM DIMENSION CAN BE INCREASED PROPORTIONATE TO THE MAXIMUM ALLOWABLE LOAD.
2. ALL SHARP CORNERS SHALL BE ROUNDED OFF.
3. DOUBLER PLATE IS APPLICABLE ONLY WHEN SUPPORT IS WELDED ON BULKHEAD.
4. FOR DOUBLER PLATE, REFER STANDARD DP01
5. DIMENSIONS A, B, C, D TO BE FOLLOWED AS PER PIPING GA

ONLY FOR REFERENCE


All dimensions in mm unless noted otherwise; Do not scale the drawing

**S&O MARITIME SERVICES PVT. LTD.**

Cheriya Vappalassery  
Mekkad PO, Nedumbassery (NH-544)  
Ernakulam 683589, Kerala, India  
E-mail : info@SandOmaritime.com, Web : www.SandOmaritime.com

This drawing or document is the property of S&O Maritime Services Pvt. Ltd. and must in no case wholly or partially be copied, shown or given to a third party without the expressed consent of S&O Maritime Services Pvt. Ltd.

### HANGER 'L' TYPE SUPPORT (HS-03)

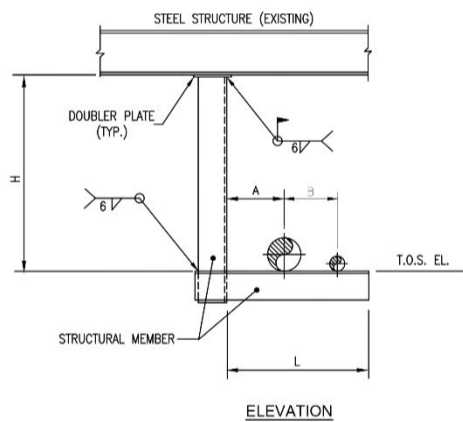

ITEM NO.	DESCRIPTION	MATERIAL
1	PLATE	ASTM A36
2	ANGLE	ASTM A36

MEMBER SIZE REF.	SIZE OF STRUCTURAL MEMBER	MAX. HEIGHT 'H' (NOTE-1)	MAX. LENGTH 'L' (NOTE-1)	MAX. LOAD IN KG
1	ANGLE 80x80x8	500mm	300mm	300
2	ANGLE 100x100x10	750mm	500mm	400
3	CHANNEL 152x76x18	1000mm	600mm	500


**NOTES**

1. MAXIMUM DIMENSION OF SUPPORT AND LOAD GIVEN IN THE TABLE FOR GUIDANCE ONLY. FOR LOWER LOAD MAXIMUM DIMENSION CAN BE INCREASED PROPORTIONATE TO THE MAXIMUM ALLOWABLE LOAD.
2. ALL SHARP CORNERS SHALL BE ROUNDED OFF.
3. DOUBLER PLATE IS APPLICABLE ONLY WHEN SUPPORT IS WELDED ON BULKHEAD.
4. FOR DOUBLER PLATE, REFER STANDARD DP01
5. DIMENSIONS A, B TO BE FOLLOWED AS PER PIPING GA

Rev	Date	Drawn	Checked	Revision	Subject

Client					---
Project / Vessel					---
Drawing Name					STANDARD SUPPORT DRAWING
Drawing No:	Rev	Sheet	Scale	Size	
---	---	7 OF 10	1:1	A3	

### CANTILEVER SUPPORT-4 (CL-04)

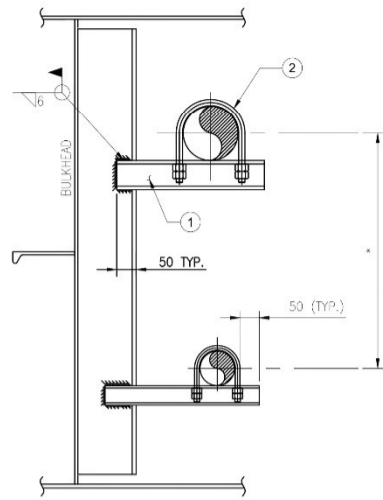

#### MATERIAL SELECTION MATRIX

PIPE SIZE (INCH)	NO. OF PIPES			
	1	2	3	4
3/8"	A	A	A	A
1/2"	A	A	A	A
1"	A	A	A	A
1 1/4"	A	A	A	A
1 1/2"	A	A	A	A
2"	A	A	A	A
2 1/2"	A	A	A	A
3"	A	A	A	A
4"	A	A	A	B
5"	B	B	B	B
6"	B	B	C	C
8"	B	B	C	C
10"	C	C	D	D

#### KEY TO MATERIALS

IDENT.	ANGLE/CHANNEL SIZE
A	L50 x 50 x 6
B	L75 x 75 x 9
C	L100 x 100 x 13
D	C160 x 65 x 18.8

#### ITEMS LIST

ITEM	QTY	DESCRIPTION
1	1	ANGLE/CHANNEL, GR A-36 OR SIM. (SEE TABLE)
2	1	U-BOLT (SEE STD UB-02)

#### NOTE

- ALL SHARP CORNERS SHALL BE ROUNDED OFF.

ONLY FOR REFERENCE

All dimensions in mm unless noted otherwise; Do not scale the drawing




**S&O MARITIME SERVICES PVT. LTD.**

Cheriyappalassery  
Mekkad PO, Nedumbassery (NH-544)  
Ernakulam 683589, Kerala, India  
E-mail : info@SandOmaritime.com, Web : www.SandOmaritime.com

This drawing or document is the property of S&O Maritime Services Pvt. Ltd. and must in no case wholly or partially be copied, shown or given to a third party without the expressed consent of S&O Maritime Services Pvt. Ltd.

### HANGER SUPPORT (HS-01)

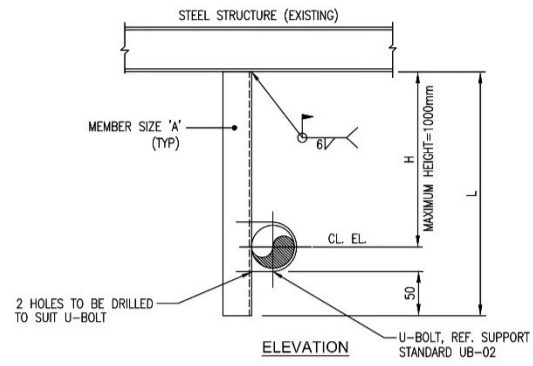

ITEM NO.	DESCRIPTION	MATERIAL
1	ANGLE	ABS GR. A36 OR EQUAL

MEMBER SIZE REF.	SIZE OF STRUCTURAL MEMBER	MAX. HEIGHT 'H'	MAX. LOAD IN KG.
1	ANGLE 90x90x8	750mm	813
2	ANGLE 100x100x10	1000mm	915

#### NOTES

- MAXIMUM DIMENSION OF SUPPORT AND LOAD GIVEN IN THE TABLE FOR GUIDANCE ONLY. FOR LOWER LOAD MAXIMUM DIMENSION CAN BE INCREASED PROPORTIONATE TO THE MAXIMUM ALLOWABLE LOAD.
- ALL SHARP CORNERS SHALL BE ROUNDED OFF.

Rev	Date	Drawn	Checked	Revision Subject
---	---	---	---	---



Client: ---

Project / Vessel: ---

Drawing Name: STANDARD SUPPORT DRAWING

Drawing No:	Rev	Sheet	Scale	Size
---	---	6 OF 10	1:1	A3

### CANTILEVER SUPPORT-3 (CL-03)

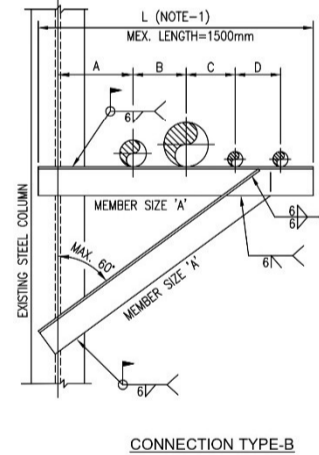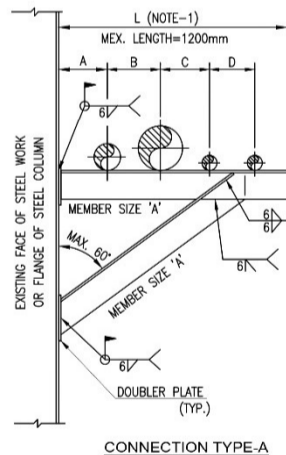

#### NOTES

- MAXIMUM DIMENSION OF SUPPORT AND LOAD GIVEN IN THE TABLE FOR GUIDANCE ONLY. FOR LOWER LOAD MAXIMUM DIMENSION CAN BE INCREASED PROPORTIONATE TO THE MAXIMUM ALLOWABLE LOAD.
- ALL SHARP CORNERS SHALL BE ROUNDED OFF.
- DOUBLER PLATE IS APPLICABLE ONLY WHEN SUPPORT IS WELDED ON BULKHEAD.
- FOR DOUBLER PLATE, REFER STANDARD DP01
- DIMENSIONS A, B, C, D TO BE FOLLOWED AS PER PIPNG GA

MEMBER SIZE REF.	SIZE OF STRUCTURAL MEMBER 'A'	MAX. LOAD IN KG
1	ANGLE 80x80x8	407
2	ANGLE 100x100x10	508
4	CHANNEL 152x76x18	814

ITEM NO.	DESCRIPTION	MATERIAL
1	ANGLE	ASTM A36
2	CHANNEL	ASTM A36

All dimensions in mm unless noted otherwise; Do not scale the drawing



**S&O MARITIME SERVICES PVT. LTD.**

Cheriyappalassery  
Mekkad PO, Nedumbassery (NH-544)  
Ernakulam 683589, Kerala, India  
E-mail : info@SandOmaritime.com, Web : www.SandOmaritime.com

This drawing or document is the property of S&O Maritime Services Pvt. Ltd. and must in no case wholly or partially be copied, shown or given to a third party without the expressed consent of S&O Maritime Services Pvt. Ltd.

Rev	Date	Drawn	Checked	Revision Subject
---	---	---	---	---

Client: ---



Project / Vessel: ---

Drawing Name: STANDARD SUPPORT DRAWING

Drawing No:	Rev	Sheet	Scale	Size
---	---	5 OF 10	1:1	A3

ONLY FOR REFERENCE

### CANTILEVER SUPPORT-2 (CL-02)

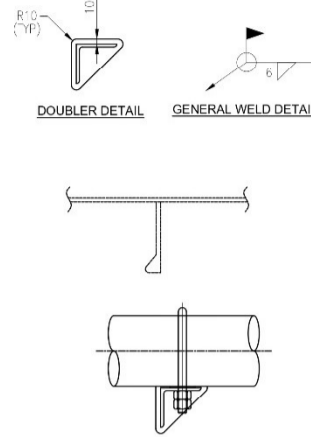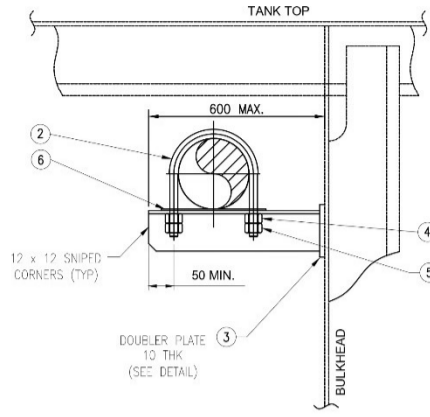

#### MATERIAL SELECTION MATRIX

PIPE SIZE (INCH)	NO. OF PIPES			
	1	2	3	4
3/8"	A	A	A	A
1/2"	A	A	A	A
1"	A	A	A	A
1 1/4"	A	A	A	A
1 1/2"	A	A	A	A
2"	A	A	A	A
2 1/2"	A	A	A	A
3"	A	A	A	A
4"	A	A	A	B
5"	B	B	B	B
6"	B	B	C	C
8"	B	B	C	C
10"	C	C	D	D

#### NOTES

- 'U' BOLT HOT DIP GALVANISED OR EQUIVALENT.
- ALL SHARP CORNERS SHALL BE ROUNDED OFF.
- DOUBLER PLATE IS APPLICABLE ONLY WHEN SUPPORT IS WELDED ON BULKHEAD.
- FOR DOUBLER PLATE, REFER STANDARD DP01
- CARE TO BE TAKEN WHEN LOCATING SUPPORTS, TO ENSURE ALIGNMENT WITH STRUCTURAL MEMBERS.

#### KEY TO MATERIALS

IDENT.	ANGLE/CHANNEL SIZE	DOUBLER SIZE
A	L50 x 50 x 6	80 x 80 x 10
B	75 x 75 x 9	110 x 110 x 10
C	L100 x 100 x 13	125 x 125 x 10
D	C160 x 65 x 18.8	190 x 90 x 10

#### ITEMS LIST

ITEM	QTY.	DESCRIPTION
1	-	ANGLE/CHANNEL, GR A-36 OR SIM.
2	-	'U' BOLT AND 4 HEX NUTS (REF STD P2A)
3	-	DOUBLER PLT, GR A-36 OR SIM.
4	-	NUTS (REF STD P2A)
5	-	LOCKNUTS (REF STD P2A)
6	-	PAD (REF STD P2A)


ONLY FOR REFERENCE

All dimensions in mm unless noted otherwise; Do not scale the drawing

	<b>S&amp;O MARITIME SERVICES PVT. LTD.</b> Cheriya Vappalassery Mekkad PO, Nedumbassery (NH-544) Ernakulam 683589, Kerala, India E-mail : info@SandOmaritime.com, Web : www.SandOmaritime.com	Client	---
	Project / Vessel		---
Drawing Name		STANDARD SUPPORT DRAWING	
Drawing No:	Rev	Sheet	Scale
---	-	4 OF 10	1:1
		Size	A3

This drawing or document is the property of S&O Maritime Services Pvt. Ltd. and must in no case wholly or partially be copied, shown or given to a third party without the expressed consent of S&O Maritime Services Pvt. Ltd.

### CANTILEVER SUPPORT-1 (CL-01)

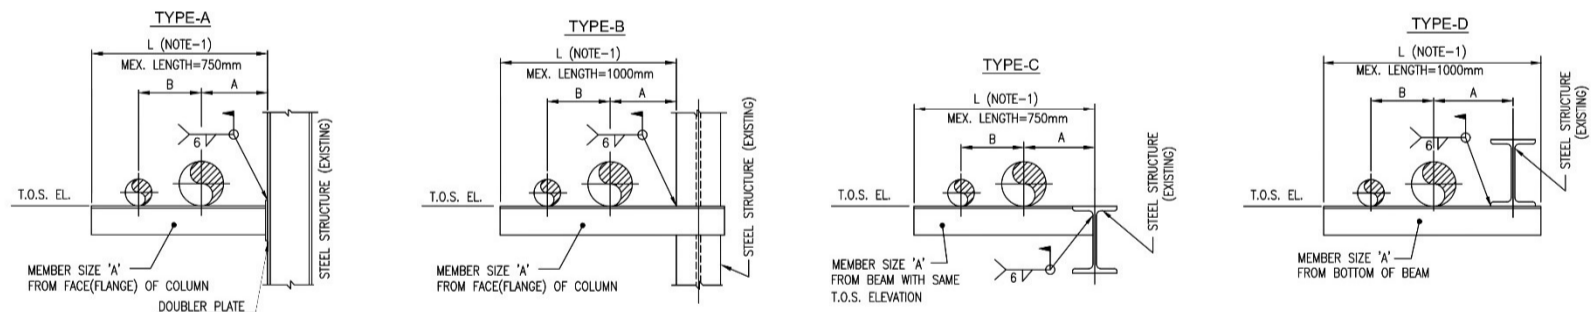

#### NOTES

- MAXIMUM DIMENSION OF SUPPORT AND LOAD GIVEN IN THE TABLE FOR GUIDANCE ONLY. FOR LOWER LOAD MAXIMUM DIMENSION CAN BE INCREASED PROPORTIONATE TO THE MAXIMUM ALLOWABLE LOAD.
- ALL SHARP CORNERS SHALL BE ROUNDED OFF.
- DOUBLER PLATE IS APPLICABLE ONLY WHEN SUPPORT IS WELDED ON BULKHEAD.
- FOR DOUBLER PLATE, REFER STANDARD DP01
- DIMENSIONS A, B TO BE FOLLOWED AS PER PIPING GA

ITEM NO.	DESCRIPTION	MATERIAL
1	ANGLE	ASTM A36

MEMBER SIZE REF.	SIZE OF STRUCTURAL MEMBER 'A'	MAX. LOAD IN KG.
1	ANGLE 80x80x8	110
2	ANGLE 100x100x10	151
3	ANGLE 120x120x10	305


ONLY FOR REFERENCE

All dimensions in mm unless noted otherwise; Do not scale the drawing

	<b>S&amp;O MARITIME SERVICES PVT. LTD.</b> Cheriya Vappalassery Mekkad PO, Nedumbassery (NH-544) Ernakulam 683589, Kerala, India E-mail : info@SandOmaritime.com, Web : www.SandOmaritime.com	Client	---
	Project / Vessel		---
Drawing Name		STANDARD SUPPORT DRAWING	
Drawing No:	Rev	Sheet	Scale
---	-	3 OF 10	1:1
		Size	A3

This drawing or document is the property of S&O Maritime Services Pvt. Ltd. and must in no case wholly or partially be copied, shown or given to a third party without the expressed consent of S&O Maritime Services Pvt. Ltd.

## ANGLE POST SUPPORT (AP-01)

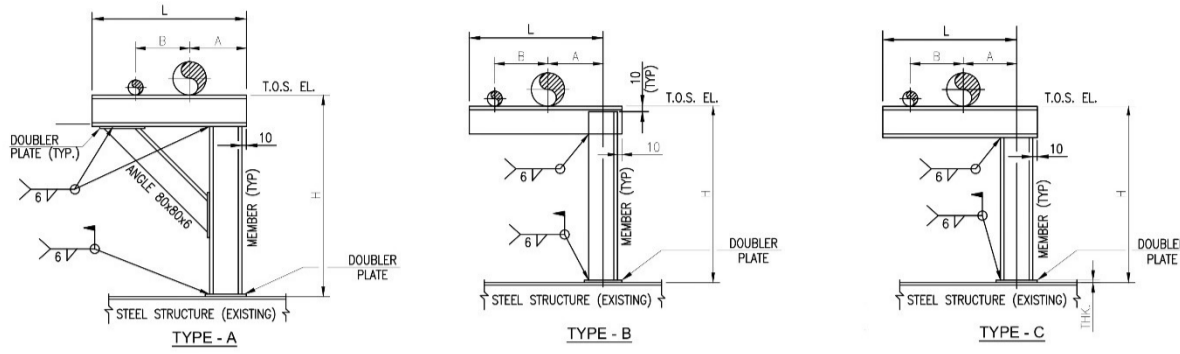

ITEM NO.	DESCRIPTION	MATERIAL
1	STEEL/PROFILE	ASTM A36
2	PLATE	ASTM A36

REF.	SUPPORT MEMBER SIZE	H (MAX.) NOTE 1	L (MAX.) NOTE 1	MAX. LOAD IN KG.
1	ANGLE 100x100x10	750mm	500mm	610
2	ANGLE 80x80x8	500mm	300mm	250
3	ANGLE 80x80x6	500mm	300mm	230
4	UPN-100x50x10.6	750mm	500mm	1525
5	CHANNEL 152x76x18	1000mm	600mm	2030
6	CHANNEL 203x76x24	2500mm	1500mm	1020

- NOTES**
1. MAXIMUM DIMENSION OF SUPPORT AND LOAD GIVEN IN THE TABLE FOR GUIDANCE ONLY. FOR LOWER LOAD MAXIMUM DIMENSION CAN BE INCREASED PROPORTIONATE TO THE MAXIMUM ALLOWABLE LOAD.
  2. ALL SHARP CORNERS SHALL BE ROUNDED OFF.
  3. DOUBLER PLATE IS APPLICABLE ONLY WHEN SUPPORT IS WELDED ON BULKHEAD.
  4. FOR DOUBLER PLATE, REFER STANDARD DPO1
  5. DIMENSIONS A, B TO BE FOLLOWED AS PER PIPNG GA

ONLY FOR REFERENCE

All dimensions in mm unless noted otherwise; Do not scale the drawing

**S&O MARITIME SERVICES PVT. LTD.**


Cheriyappalassery  
Mekkad PO, Nedumbassery (NH-544)  
Ernakulam 683589, Kerala, India  
E-mail : info@SandOmaritime.com, Web : www.SandOmaritime.com

This drawing or document is the property of S&O Maritime Services Pvt. Ltd. and must in no case wholly or partially be copied, shown or given to a third party without the expressed consent of S&O Maritime Services Pvt. Ltd.

Rev	Date	Drawn	Checked	Revision Subject

Client				
Project / Vessel				
Drawing Name				
STANDARD SUPPORT DRAWING				
Drawing No:	Rev	Sheet	Scale	Size
---	-	2 OF 10	1:1	A3

## PIPING SUPPORT (PS01)

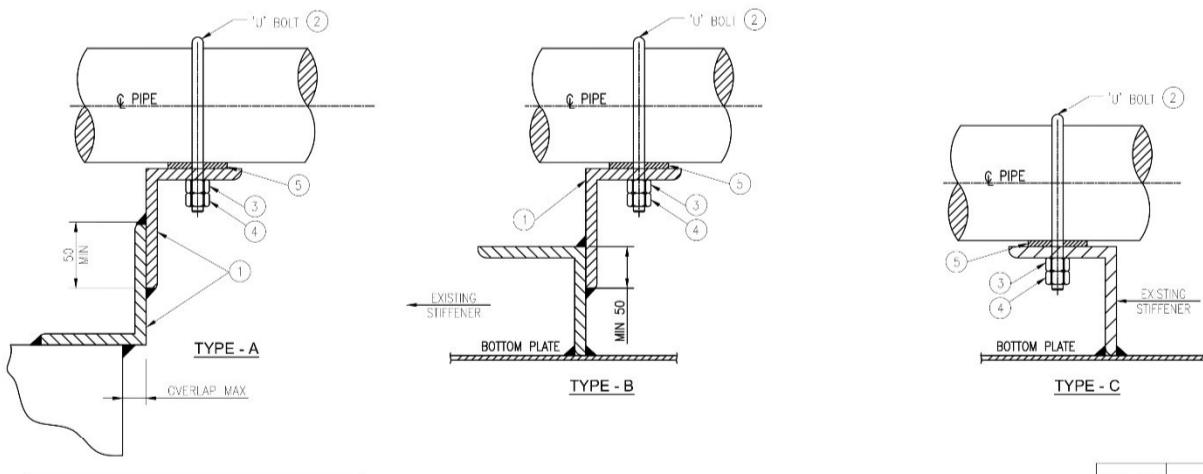

ITEMS LIST

ITEM	QTY	DESCRIPTION
1	2	ANGLE BAR, GR A-36 OR SIM.
2	1	U-BOLT (SEE STD UB-02)
3	2	NUTS (SEE STD UB-02)
4	2	LOCKNUTS (SEE STD UB-02)
5	1	

PIPE SIZE (INCH)	MAX OVERLAP ALLOWABLE (mm)		
	L50x50x6	L75x75x9	L100x100x7
2"	25	55	75
2½"	25	55	75
3"	25	55	75
4"	25	55	75
5"	25	55	75
6"	25	55	75
8"	25	55	75
10"	25	40	75

ONLY FOR REFERENCE

All dimensions in mm unless noted otherwise; Do not scale the drawing

**S&O MARITIME SERVICES PVT. LTD.**



Cheriyappalassery  
Mekkad PO, Nedumbassery (NH-544)  
Ernakulam 683589, Kerala, India  
E-mail : info@SandOmaritime.com, Web : www.SandOmaritime.com

This drawing or document is the property of S&O Maritime Services Pvt. Ltd. and must in no case wholly or partially be copied, shown or given to a third party without the expressed consent of S&O Maritime Services Pvt. Ltd.

Rev	Date	Drawn	Checked	Revision Subject

Client				
Project / Vessel				
Drawing Name				
STANDARD SUPPORT DRAWING				
Drawing No:	Rev	Sheet	Scale	Size
---	-	1 OF 10	1:1	A3

# Isometric piping arrangement Sample Drawings: -

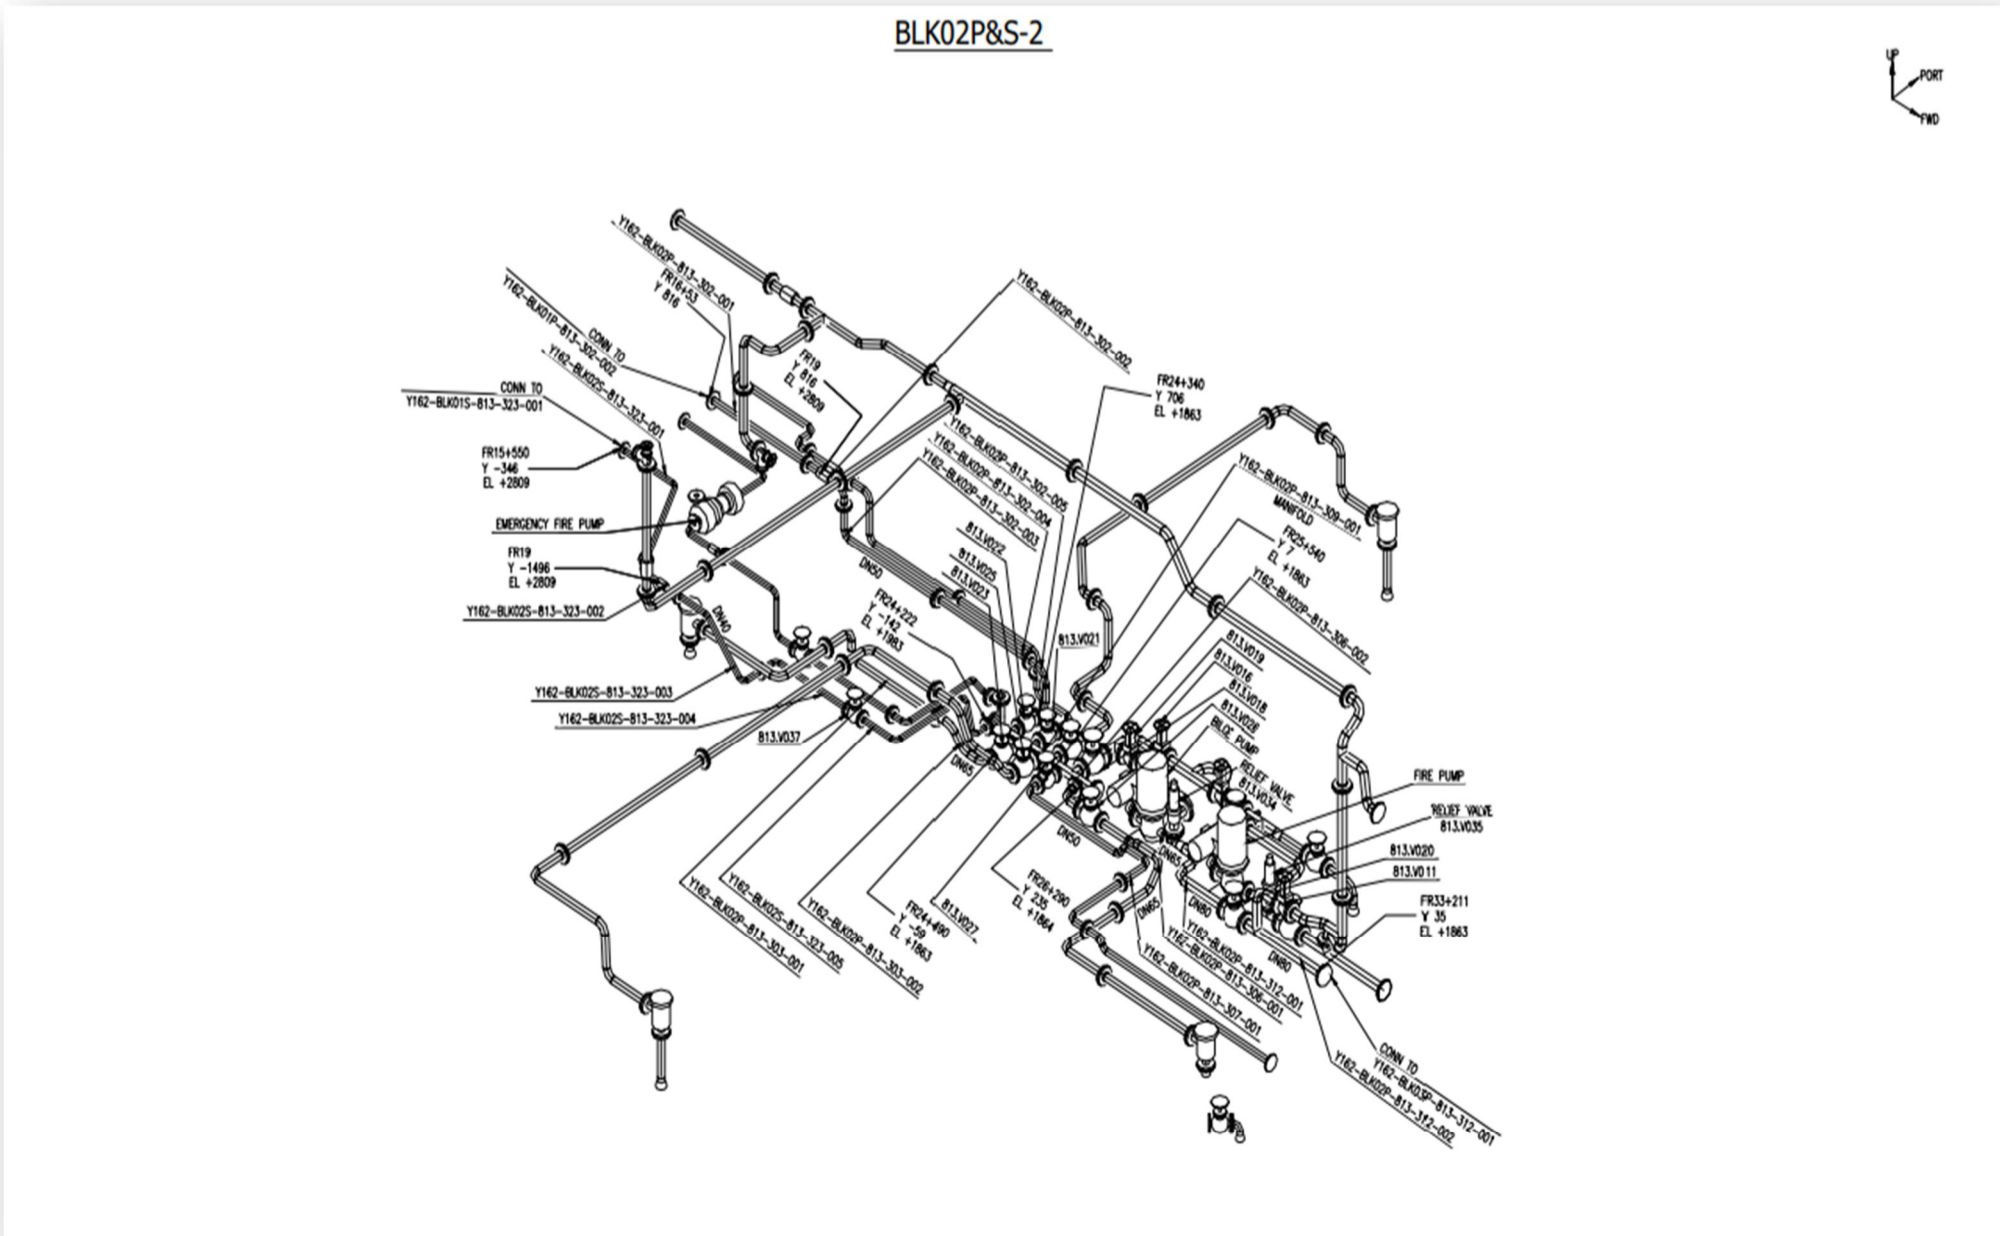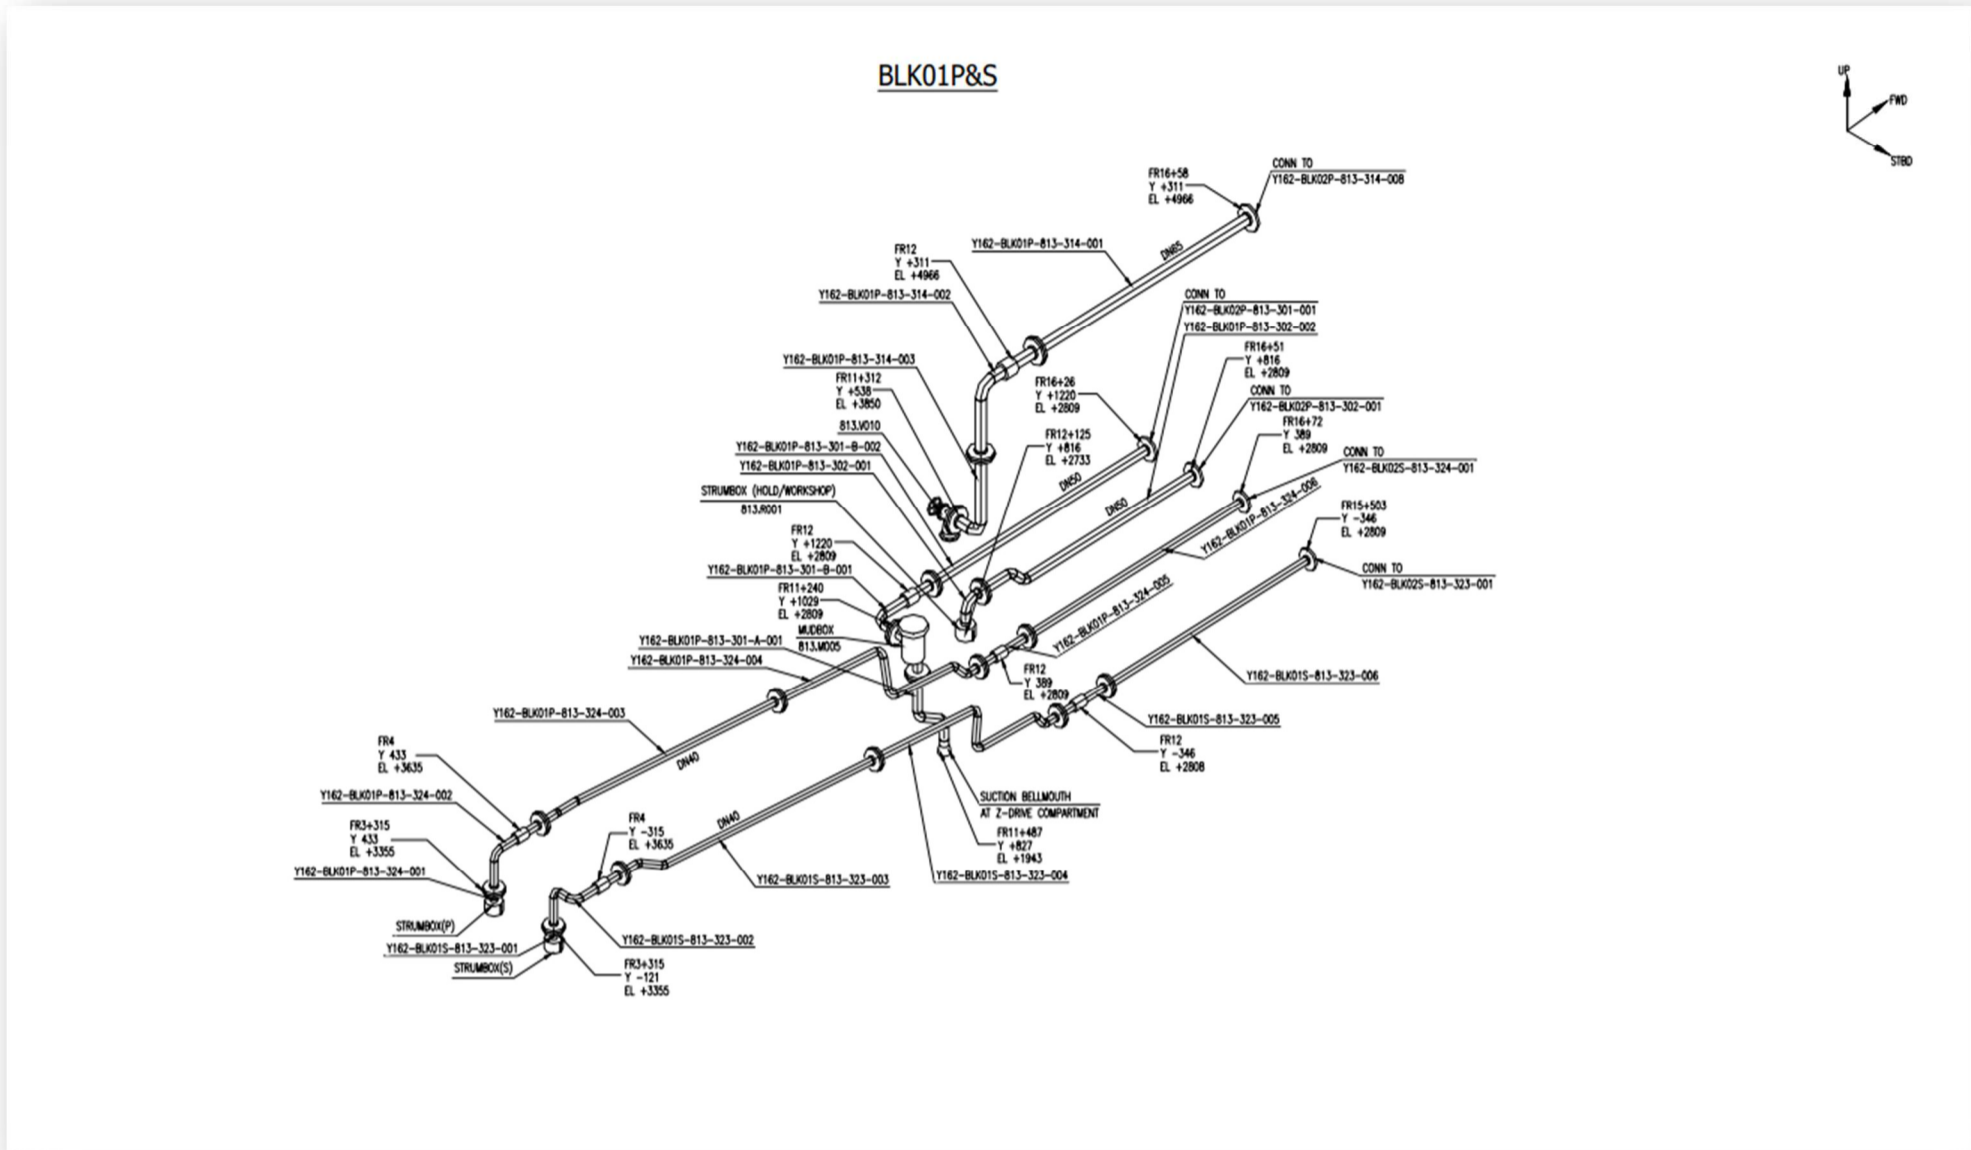

## Encl 3 Penetration List

## PRELIMINARY PENETRATION LIST - TUG PROJECT / VESSEL

SL. NO.	PEN NO.	PEN TYPE	SYSTEM	BLOCK NO.	PIPE SIZE	CUT OUT SIZE	X	Y	Z	PENETRATION SURFACE
1	PN-TW-01	TYPE-2	TECHNICAL WATER	1	DN50	96	FR.4	PS 150	3700 ABL	BHD
2	PN-TW-02	TYPE-2	TECHNICAL WATER	1	DN50	96	FR.4	SB 150	3700 ABL	BHD
3	PN-MC-01	OBD	MACHINERY COOLING	1	DN80	95	FR.10 + 275	SB	4100 ABL	SIDE SHELL
4	PN-MC-02	OBD	MACHINERY COOLING	1	DN50	66	FR.12-274	SB	4100 ABL	SIDE SHELL
5	PN-MC-03	OBD	MACHINERY COOLING	1	DN80	95	FR.11-274	PS	4100 ABL	SIDE SHELL
6	PN-MC-04	OBD	MACHINERY COOLING	1	DN50	66	FR.12-274	PS	4100 ABL	SIDE SHELL
7	PN-MC-05	TYPE-1	MACHINERY COOLING	1	DN80	120	FR.13	SB 1834	2327 ABL	BHD
8	PN-MC-01	TYPE-1	MACHINERY COOLING	1	DN80	120	FR.13	SB 1355	2125 ABL	BHD
9	PN-TW-03	TYPE-1	TECHNICAL WATER	1	DN50	96	FR.13	SB 1925	2120 ABL	BHD
10	PN-TW-04	TYPE-1	TECHNICAL WATER	1	DN50	96	FR.13	SB 1735	2120 ABL	BHD
11	PN-MC-07	TYPE-1	MACHINERY COOLING	1	DN50	96	FR.13	SB 3054	4755 ABL	BHD
12	PN-FO-01	TYPE-1	FUEL OIL	1	DN80	120	FR.13	SB 3054	4347 ABL	BHD
13	PN-CA-01	TYPE-1	COMPRESSED AIR	1	DN25	54	FR.13	SB 354	2113 ABL	BHD
14	PN-BF-01	TYPE-1	BILGE AND FIRE	1	DN50	96	FR.13	SB 750	2400 ABL	BHD
15	PN-BF-02	TYPE-2	BILGE AND FIRE	1	DN65	120	FR.13	SB 385	4400 ABL	BHD
16	PN-MC-08	TYPE-1	MACHINERY COOLING	1	DN50	96	FR.13	PS 3121	4794 ABL	BHD
17	PN-FO-02	TYPE-1	FUEL OIL	1	DN80	120	FR.13	PS 3271	4347 ABL	BHD
18	PN-HVAC-01	TYPE-4	HVAC	1	DN200	280	FR.13	SB 2250	4700 ABL	BHD
19	PN-HVAC-02	TYPE-4	HVAC	1	DN200	280	FR.13	PS 3654	4680 ABL	BHD
20	PN-FO-03	BHD FLANGE	FUEL OIL	2	DN50		FR.14+251	SB 4050	4800 ABL	BHD
21	PN-FO-04	BHD FLANGE	FUEL OIL	2	DN32		FR.15+131	SB 4050	4900 ABL	BHD
22	PN-FO-05	BHD FLANGE	FUEL OIL	2	DN40		FR.16+200	SB 4050	4750 ABL	BHD
23	PN-FO-06	BHD FLANGE	FUEL OIL	2	DN50		FR.18+200	SB 4050	4090 ABL	BHD
24	PN-FA-	TYPE-3	FILL VENT AND SOUNDING	2	DN65	120	FR.19-104	SB 4050	4125 ABL	BHD
25	PN-FO-07	BHD FLANGE	FUEL OIL	2	DN20		FR.19	SB 4138	4333 ABL	BHD
26	PN-FO-08	BHD FLANGE	FUEL OIL	2	DN50		FR.17+205	PS 4050	4964 ABL	BHD
27	PN-FO-09	BHD FLANGE	FUEL OIL	2	DN50		FR.18+198	PS 4050	4042 ABL	BHD
28	PN-FA-	TYPE-3	FILL VENT AND SOUNDING	2	DN65	120	FR.19	PS 4731	5053 ABL	BHD
29	PN-FO-010	BHD FLANGE	FUEL OIL	2	DN20		FR.19	PS 4800	4333 ABL	BHD
30	PN-FO-011	BHD FLANGE	FUEL OIL	2	DN32		FR.19	PS 5100	4900 ABL	BHD
31	PN-FO-012	BHD FLANGE	FUEL OIL	2	DN40		FR.19	PS 5428	4749 ABL	BHD
32	PN-FA-	TYPE-3	FILL VENT AND SOUNDING	2	DN65	120	FR.19	PS 5475	4112 ABL	BHD
33	PN-FA-	TYPE-3	FILL VENT AND SOUNDING	2	DN65	120	FR.13+122	PS 1929	2000 ABL	TANK TOP
34	PN-FA-	TYPE-4	FILL VENT AND SOUNDING	2	DN65	120	FR.19-99	PS 100	2000 ABL	TANK TOP
35	PN-FA-	TYPE-3	FILL VENT AND SOUNDING	2	DN65	120	FR.22-168	SB 5390	2000 ABL	TANK TOP
36	PN-FA-	TYPE-3	FILL VENT AND SOUNDING	2	DN65	120	FR.21-222	PS 5390	2000 ABL	TANK TOP
37	PN-SO-01	OBD	SLUDGE & OILY WATER	2	DN40	54	FR.20+275	PS	4006 ABL	SIDE SHELL
38	PN-SD-01	OBD	SCUPPERS AND DRAIN	2	DN50	66	FR.21+275	PS	4006 ABL	SIDE SHELL
39	PN-FA-	TYPE-4	FILL VENT AND SOUNDING	2	DN40	79	FR.19-175	SB 4375	4200 ABL	DAY TANK BOTTOM
40	PN-FA-	TYPE-4	FILL VENT AND SOUNDING	2	DN40	79	FR.19-174	PS 4750	4200 ABL	DAY TANK BOTTOM
41	PN-SO-02	TYPE-3	SLUDGE & OILY WATER	2	DN25	54	FR.23-194	SB 1517	1400 ABL	TANK TOP
42	PN-FO-013	TYPE-3	FUEL OIL	2	DN80	120	FR.19+201	PS 1876	1400 ABL	TANK TOP
43	PN-FO-014	DECK PEN FLANGE	FUEL OIL	2	DN50		FR.20-49	PS 1219	1400 ABL	TANK TOP
44	PN-FA-	TYPE-3	FILL VENT AND SOUNDING	2	DN100	146	FR.20+101	PS 1876	1400 ABL	TANK TOP
45	PN-FO-015	DECK PEN FLANGE	FUEL OIL	2	DN15		FR.21-203	PS 1219	1400 ABL	TANK TOP
46	PN-FA-	TYPE-3	FILL VENT AND SOUNDING	2	DN80	120	FR.21-274	PS 312	1400 ABL	TANK TOP
47	PN-FA-	TYPE-4	FILL VENT AND SOUNDING	2	DN40	79	FR.21-150	PS 105	1400 ABL	TANK TOP
48	PN-SO-03	TYPE-4	SLUDGE & OILY WATER	2	DN40	79	FR.22+107	SB 35	1400 ABL	TANK TOP
49	PN-SO-04	TYPE-4	SLUDGE & OILY WATER	2	DN40	79	FR.22+264	PS 150	1400 ABL	TANK TOP
50	PN-FA-	TYPE-4	FILL VENT AND SOUNDING	2	DN40	79	FR.23-262	SB 125	1400 ABL	TANK TOP
51	PN-FA-	TYPE-3	FILL VENT AND SOUNDING	2	DN65	120	FR.23-87	SB 93	1400 ABL	TANK TOP
52	PN-FA-	TYPE-4	FILL VENT AND SOUNDING	2	DN40	79	FR.23-125	PS 150	1400 ABL	TANK TOP
53	PN-FA-	TYPE-3	FILL VENT AND SOUNDING	2	DN80	120	FR.23-145	PS 615	1400 ABL	TANK TOP
54	PN-SO-05	TYPE-3	SLUDGE & OILY WATER	2	DN40	79	FR.23-145	PS 795	1400 ABL	TANK TOP
55	PN-SO-06	TYPE-3	SLUDGE & OILY WATER	2	DN65	120	FR.23-145	PS 968	1400 ABL	TANK TOP
56	PN-FA-	TYPE-3	FILL VENT AND SOUNDING	3	DN65	120	FR.24-184	SB 283	1400 ABL	TANK TOP
57	PN-FO-016	DECK PEN FLANGE	FUEL OIL	3	DN50		FR.26+190	SB 3525	1400 ABL	TANK TOP
58	PN-FO-017	DECK PEN FLANGE	FUEL OIL	3	DN50		FR.26+177	PS 3521	1400 ABL	TANK TOP
59	PN-FO-018	DECK PEN FLANGE	FUEL OIL	3	DN50		FR.28+233	SB 837	1400 ABL	TANK TOP
60	PN-FA-	TYPE-3	FILL VENT AND SOUNDING	3	DN50	96	FR.30+200	SB 1900	850 ABL	SEA CHEST
61	PN-MC-09	SEA CHEST	MACHINERY COOLING	3	DN200		FR.30+269	SB 1604	850 ABL	SEA CHEST
62	PN-FA-	TYPE-3	FILL VENT AND SOUNDING	3	DN15	54	FR.31-154	SB 1309	850 ABL	SEA CHEST
63	PN-FA-	TYPE-3	FILL VENT AND SOUNDING	3	DN15	54	FR.31-154	PS 1309	850 ABL	SEA CHEST
64	PN-MC-10	SEA CHEST	MACHINERY COOLING	3	DN200		FR.30+269	PS 1605	850 ABL	SEA CHEST
65	PN-FA-	TYPE-3	FILL VENT AND SOUNDING	3	DN50	96	FR.31-154	PS 1900	850 ABL	SEA CHEST
66	PN-FA-	TYPE-3	FILL VENT AND SOUNDING	3	DN50	96	FR.31+150	PS 2750	1400 ABL	FIFI SEA CHEST
67	PN-FA-	TYPE-3	FILL VENT AND SOUNDING	3	DN15	54	FR.33-256	PS 2825	1400 ABL	FIFI SEA CHEST
68	PN-FI-	SEA CHEST	EXTERNAL FIFI	3	REDUCER		FR.33+50	PS 2500	1400 ABL	FIFI SEA CHEST
69	PN-FA-	TYPE-4	FILL VENT AND SOUNDING	3	DN40	79	FR.32-134	SB 150	1400 ABL	TANK TOP
70	PN-FA-	TYPE-4	FILL VENT AND SOUNDING	3	DN40	79	FR.32+194	SB 150	1400 ABL	TANK TOP
71	PN-FA-	TYPE-4	FILL VENT AND SOUNDING	3	DN40	79	FR.32+124	PS 142	1400 ABL	TANK TOP
72	PN-FI-	TYPE-4	EXTERNAL FIFI	3	DN15	54	FR.33-183	SB 150	1400 ABL	TANK TOP
73	PN-OD-	TYPE-4	DISPERSANT	3	DN25	54	FR.33-273	PS 142	1400 ABL	TANK TOP
74	PN-FA-	TYPE-4	FILL VENT AND SOUNDING	3	DN40	79	FR.36-200	SB 3075	1400 ABL	TANK TOP
75	PN-FA-	TYPE-3	FILL VENT AND SOUNDING	3	DN65	120	FR.34-196	SB 1927	1400 ABL	TANK TOP
76	PN-FA-	TYPE-3	FILL VENT AND SOUNDING	3	DN50	96	FR.35+59	SB 1968	1400 ABL	TANK TOP
77	PN-FA-	TYPE-3	FILL VENT AND SOUNDING	3	DN65	120	FR.34+231	PS 1772	1400 ABL	TANK TOP
78	PN-FA-	TYPE-4	FILL VENT AND SOUNDING	3	DN50	96	FR.35-119	PS 1772	1400 ABL	TANK TOP
79	PN-FA-	TYPE-4	FILL VENT AND SOUNDING	3	DN40	79	FR.36-200	PS 2200	1400 ABL	TANK TOP
80	PN-BG-	TYPE-1	BLACK & GREY	3	DN50	96	FR.36	SB 4515	3205 ABL	BHD
81	PN-BF-05	TYPE-1	BILGE AND FIRE	3	DN50	96	FR.36	SB 4510	3405 ABL	BHD
82	PN-BG-	TYPE-1	BLACK & GREY	3	DN80	120	FR.36	SB 4523	3685 ABL	BHD
83	PN-BG-	TYPE-1	BLACK & GREY	3	DN80	120	FR.36	SB 4153	3629 ABL	BHD
84	PN-TW-	TYPE-1	TECHNICAL WATER	3	DN50	96	FR.36	SB 4153	2585 ABL	BHD
85	PN-TW-	TYPE-1	TECHNICAL WATER	3	DN50	96	FR.36	SB 4153	2775 ABL	BHD
86	PN-BG-	TYPE-1	BLACK & GREY	3	DN100	146	FR.36	SB 1699	3679 ABL	BHD
87	PN-MC-	TYPE-1	MACHINERY COOLING	3	DN65	120	FR.36	SB 1268	1722 ABL	BHD
88	PN-FA-	TYPE-2	FILL VENT AND SOUNDING	3	DN65	120	FR.36	SB 1164	3831 ABL	BHD
89	PN-BG-	TYPE-1	BLACK & GREY	3	DN50	96	FR.36	SB 339	3879 ABL	BHD

90	PN-BF-06	TYPE-1	BILGE AND FIRE	3	DN32	66	FR.36	SB 175	3865 ABL	BHD
91	PN-FA	TYPE-2	FILL VENT AND SOUNDING	3	DN80	120	FR.36	PS 767	3856 ABL	BHD
92	PN-BF-07	TYPE-1	BILGE AND FIRE	3	DN50	96	FR.36	PS 1205	1513 ABL	BHD
93	PN-BF-08	TYPE-1	BILGE AND FIRE	3	DN50	96	FR.36	PS 1405	1513 ABL	BHD
94	PN-BF-09	TYPE-1	BILGE AND FIRE	3	DN65	120	FR.36	SB 190	6440 ABL	BHD
95	PN-CA	TYPE-1	COMPRESSED AIR	3	DN25	54	FR.36	PS 1995	1500 ABL	BHD
96	PN-BG	TYPE-1	BLACK & GREY	3	DN50	96	FR.36	PS 3501	3876 ABL	BHD
97	PN-BF-26	TYPE-1	BILGE AND FIRE	3	DN50	96	FR.36	PS 4710	3845 ABL	BHD
98	PN-BG	TYPE-3	BLACK & GREY	4	DN80	120	FR.37-231	SB 1439	1400 ABL	TANK TOP
99	PN-FA	TYPE-3	FILL VENT AND SOUNDING	4	DN65	120	FR.37-247	SB 801	1400 ABL	TANK TOP
100	PN-BG	TYPE-3	BLACK & GREY	4	DN50	96	FR.36+267	SB 601	1400 ABL	TANK TOP
101	PN-BG	TYPE-4	BLACK & GREY	3	DN50	96	FR.36+100	SB 310	1400 ABL	TANK TOP
102	PN-FA	TYPE-4	FILL VENT AND SOUNDING	4	DN40	79	FR.36+200	SB 140	1400 ABL	TANK TOP
103	PN-BG	TYPE-4	BLACK & GREY	3	DN50	96	FR.36+100	PS 265	1400 ABL	TANK TOP
104	PN-BG	TYPE-3	BLACK & GREY	3	DN100	146	FR.36+127	PS 540	1400 ABL	TANK TOP
105	PN-FA	TYPE-3	FILL VENT AND SOUNDING	4	DN80	120	FR.36+214	PS 767	1400 ABL	TANK TOP
106	PN-BF-18	TYPE-2	BILGE AND FIRE	4	DN50	96	FR.42-250	SB 1000	1245 ABL	BHD
107	PN-BF-19	TYPE-2	BILGE AND FIRE	4	DN50	96	FR.42-250	PS 1000	1245 ABL	BHD
108	PN-FA	TYPE-3	FILL VENT AND SOUNDING	4	DN40	79	FR.41+150	PS 1000	412 ABL	BHD
109	PN-FA	TYPE-3	FILL VENT AND SOUNDING	4	DN40	79	FR.41+150	PS 1000	3951 ABL	BHD
110	PN-FA	TYPE-3	FILL VENT AND SOUNDING	4	DN40	79	FR.41+150	SB 1000	412 ABL	BHD
111	PN-FA	TYPE-3	FILL VENT AND SOUNDING	4	DN40	79	FR.41+150	SB 1000	3951 ABL	BHD
112	PN-PW	TYPE-2	POTABLE WATER	4	DN40	79	FR.44-155	SB 1000	1513ABL	BHD
113	PN-PW	TYPE-2	POTABLE WATER	4	DN40	79	FR.44-155	PS 1000	1513ABL	BHD
114	PN-TW	TYPE-4	TECHNICAL WATER	4	DN50	96	FR.44	PS 214	1840 ABL	BHD
115	PN-TW	TYPE-2	TECHNICAL WATER	4	DN50	96	FR.47	PS 214	1840 ABL	BHD
116	PN-BF-24	TYPE-2	BILGE AND FIRE	4	DN50	96	FR.47	PS 3025	4750 ABL	BHD
117	PN-MC	OBD	MACHINERY COOLING	3	DN80	95	FR.23+249	SB	4101 ABL	SIDE SHELL
118	PN-SD	OBD	SCUPPERS AND DRAIN	3	DN50	66	FR.24+250	SB	4101 ABL	SIDE SHELL
119	PN-BG	OBD	BLACK & GREY	3	DN80	95	FR.26-239	SB	4251 ABL	SIDE SHELL
120	PN-BG	OBD	BLACK & GREY	3	DN50	66	FR.27-239	SB	4251 ABL	SIDE SHELL
121	PN-BF-22	OBD	BILGE AND FIRE	3	DN50	66	FR.28-250	SB	4400 ABL	SIDE SHELL
122	PN-MC	OBD	MACHINERY COOLING	3	DN65	79	FR.28+275	SB	4101 ABL	SIDE SHELL
123	PN-MC	OBD	MACHINERY COOLING	3	DN80	95	FR.23+269	PS	4101 ABL	SIDE SHELL
124	PN-MC	OBD	MACHINERY COOLING	3	DN20	32	FR.26+262	PS	4100 ABL	SIDE SHELL
125	PN-BF-27	OBD	BILGE AND FIRE	3	DN50	66	FR.27-140	PS	4400 ABL	SIDE SHELL
126	PN-BF-23	OBD	BILGE AND FIRE	3	DN65	79	FR.29-240	PS	4400 ABL	SIDE SHELL
127	PN-FI	OBD	EXTERNAL FIFI	3	DN100	120	FR.30-219	PS	4325 ABL	SIDE SHELL
128	PN-FA	TYPE-3	FILL VENT AND SOUNDING	1	DN65	120	FR.3-126	SB 2750	MAIN DECK	DECK
129	PN-FA	TYPE-3	FILL VENT AND SOUNDING	1	DN65	120	FR.3-126	PS 2750	MAIN DECK	DECK
130	PN-FA	SOUNDING-FLUSH	FILL VENT AND SOUNDING	1	DN40		FR.4-176	SB 300	MAIN DECK	DECK
131	PN-FA	SOUNDING-FLUSH	FILL VENT AND SOUNDING	1	DN40		FR.4-176	PS 300	MAIN DECK	DECK
132	PN-FO	TYPE-1	FUEL OIL	1	DN80	120	FR.12+198	SB 5070	MAIN DECK	DECK
133	PN-FO	TYPE-1	FUEL OIL	1	DN80	120	FR.11+176	PS 5070	MAIN DECK	DECK
134	PN-BF-03	TYPE-1	BILGE AND FIRE	2	DN65	120	FR.18-150	SB 770	MAIN DECK	DECK
135	PN-CA	TYPE-1	COMPRESSED AIR	2	DN15	54	FR.18-123	PS 1090	MAIN DECK	DECK
136	PN-FA	TYPE-1	FILL VENT AND SOUNDING	2	DN65	120	FR.18-142	PS 1410	MAIN DECK	DECK
137	PN-FA	SOUNDING-FLUSH	FILL VENT AND SOUNDING	2	DN40		FR.19-175	SB 4375	MAIN DECK	DECK
138	PN-FA	SOUNDING-FLUSH	FILL VENT AND SOUNDING	2	DN40		FR.19-175	PS 4750	MAIN DECK	DECK
139	PN-FA	TYPE-1	FILL VENT AND SOUNDING	2	DN40	79	FR.21+150	SB 5301	MAIN DECK	DECK
140	PN-OD	TYPE-1	DISPERSENT	2	DN50	96	FR.23-252	SB 5276	MAIN DECK	DECK
141	PN-OD	TYPE-1	DISPERSENT	2	DN50	96	FR.22-200	PS 5125	MAIN DECK	DECK
142	PN-FA	TYPE-1	FILL VENT AND SOUNDING	3	DN65	120	FR.25+240	SB 5083	MAIN DECK	DECK
143	PN-FA	TYPE-1	FILL VENT AND SOUNDING	3	DN80	120	FR.25+176	PS 5060	MAIN DECK	DECK
144	PN-FA	TYPE-1	FILL VENT AND SOUNDING	3	DN50	96	FR.29-250	SB 5051	MAIN DECK	DECK
145	PN-FI	TYPE-1	EXTERNAL FIFI	3	DN50	96	FR.29+250	SB 4940	MAIN DECK	DECK
146	PN-FI	TYPE-1	EXTERNAL FIFI	3	DN80	120	FR.30-144	SB 4000	MAIN DECK	DECK
147	PN-FI	TYPE-4	EXTERNAL FIFI	3	DN350	412	FR.30+250	SB 4100	MAIN DECK	DECK
148	PN-FA	TYPE-1	FILL VENT AND SOUNDING	3	DN65	120	FR.32-274	SB 5067	MAIN DECK	DECK
149	PN-FA	TYPE-1	FILL VENT AND SOUNDING	3	DN50	96	FR.33-213	SB 5157	MAIN DECK	DECK
150	PN-BF-04	TYPE-2	BILGE AND FIRE	3	DN65	120	FR.33-250	SB 190	LOWER DECK	LOWER DECK
152	PN-BF-11	TYPE-1	BILGE AND FIRE	4	DN32	66	FR.38-170	SB 5050	LOWER DECK	LOWER DECK
153	PN-BF-13	TYPE-1	BILGE AND FIRE	4	DN32	66	FR.38+215	PS 4975	LOWER DECK	LOWER DECK
154	PN-BF-20	TYPE-2	BILGE AND FIRE	4	DN32	66	FR.48-196	SB 3543	7045 ABL	BHD - BULWARK
155	PN-BG	TYPE-1	BLACK & GREY	4	DN50	96	FR.37+175	SB 5075	MAIN DECK	DECK
156	PN-BF-12	TYPE-1	BILGE AND FIRE	4	DN25	54	FR.38-170	SB 5050	MAIN DECK	DECK
157	PN-TW	TYPE-1	TECHNICAL WATER	4	DN50	96	FR.39-168	SB 4931	MAIN DECK	DECK
158	PN-FA	TYPE-1	FILL VENT AND SOUNDING	4	DN40	79	FR.44+198	SB 4151	MAIN DECK	DECK
159	PN-FA	TYPE-1	FILL VENT AND SOUNDING	4	DN50	96	FR.46-250	SB 4055	MAIN DECK	DECK
160	PN-FA	TYPE-1	FILL VENT AND SOUNDING	4	DN65	120	FR.46+225	SB 3796	MAIN DECK	DECK
161	PN-BF-16	TYPE-1	BILGE AND FIRE	4	DN32	66	FR.47-130	SB 3865	MAIN DECK	DECK
162	PN-FA	TYPE-1	FILL VENT AND SOUNDING	4	DN65	120	FR.47+150	SB 3514	MAIN DECK	DECK
163	PN-BF-17	TYPE-1	BILGE AND FIRE	4	DN32	66	FR.48+170	SB 3300	MAIN DECK	DECK
164	PN-FA	TYPE-1	FILL VENT AND SOUNDING	5	DN65	120	FR.49-190	SB 2925	MAIN DECK	DECK
165	PN-FA	SOUNDING-FLUSH	FILL VENT AND SOUNDING	5	DN40		FR.48-255	SB 150	MAIN DECK	DECK
166	PN-CA	TYPE-1	COMPRESSED AIR	4	DN15	54	FR.38+117	SB 1221	MAIN DECK	DECK
167	PN-BF-10	TYPE-1	BILGE AND FIRE	4	DN65	120	FR.38+140	SB 190	MAIN DECK	DECK
168	PN-SO	TYPE-1	SLUDGE & OILY WATER	3	DN40	79	FR.25-155	PS 4000	MAIN DECK	DECK
169	PN-SO	TYPE-1	SLUDGE & OILY WATER	3	DN40	79	FR.25+257	PS 4000	MAIN DECK	DECK
170	PN-FI	TYPE-1	EXTERNAL FIFI	3	DN80	120	FR.28-179	PS 4000	MAIN DECK	DECK
171	PN-FA	TYPE-1	FILL VENT AND SOUNDING	3	DN80	120	FR.28+168	PS 4000	MAIN DECK	DECK
172	PN-FA	TYPE-1	FILL VENT AND SOUNDING	3	DN50	96	FR.28+156	PS 5065	MAIN DECK	DECK
173	PN-FI	TYPE-1	EXTERNAL FIFI	3	DN150	225	FR.29+275	PS 4034	MAIN DECK	DECK
174	PN-FI	TYPE-1	EXTERNAL FIFI	3	DN50	96	FR.29+195	PS 4941	MAIN DECK	DECK
175	PN-FI	TYPE-4	EXTERNAL FIFI	3	DN350	412	FR.30+250	PS 4100	MAIN DECK	DECK
176	PN-FA	TYPE-1	FILL VENT AND SOUNDING	3	DN50	96	FR.30-120	PS 5062	MAIN DECK	DECK
177	PN-FA	TYPE-1	FILL VENT AND SOUNDING	3	DN65	120	FR.30+201	PS 5067	MAIN DECK	DECK
178	PN-FA	TYPE-1	FILL VENT AND SOUNDING	3	DN50	96	FR.31-138	PS 5184	MAIN DECK	DECK
179	PN-FA	TYPE-1	FILL VENT AND SOUNDING	4	DN40	79	FR.44+198	PS 4151	MAIN DECK	DECK
180	PN-FA	TYPE-1	FILL VENT AND SOUNDING	4	DN50	96	FR.46-250	PS 4055	MAIN DECK	DECK
181	PN-FA	TYPE-1	FILL VENT AND SOUNDING	4	DN65	120	FR.46+225	PS 3796	MAIN DECK	DECK



182	PN-FA-	TYPE-3	FILL VENT AND SOUNDING	5	DN65	120	FR.48+160	PS 3360	MAIN DECK	DECK
183	PN-BF-14	TYPE-1	BILGE AND FIRE	4	DN32	66	FR.47-130	PS 3865	MAIN DECK	DECK
184	PN-BF-15	TYPE-1	BILGE AND FIRE	4	DN32	66	FR.48+170	PS 3300	MAIN DECK	DECK
185	PN-BF-21	TYPE-2	BILGE AND FIRE	4	DN32	66	FR. 48-196	PS 3543	7045 ABL	BHD - BULWARK
186	PN-LO-01	TYPE-1	LUBE OIL	DH	DN80	120	FR.23-185	SB 3210	FUNNEL TOP	FUNNEL TOP
187	PN-LO-02	TYPE-1	LUBE OIL	DH	DN80	120	FR.23-185	SB 2915	FUNNEL TOP	FUNNEL TOP
188	PN-LO-03	TYPE-1	LUBE OIL	DH	DN80	120	FR.23-185	PS 2915	FUNNEL TOP	FUNNEL TOP
189	PN-LO-04	TYPE-1	LUBE OIL	DH	DN80	120	FR.23-185	PS 3210	FUNNEL TOP	FUNNEL TOP

## Encl 4 Hydraulic tubes-fittings BOM and P&amp;IDs

**Annexure – A**

<b>1. Hydraulic Pipes</b>								
<b>a. Stainless steel Hydraulic pipes</b>								
<b>SI No.</b>	<b>Item Description</b>	<b>Material</b>	<b>Material Standard</b>	<b>Size OD (mm)</b>	<b>Thick (mm)</b>	<b>Working Pressure (bar)</b>	<b>QTY/ VESSEL (m)</b>	<b>QTY - 4 VESSEL (m)</b>
1	Seamless Precision Tube	AISI316	1 .4571,DIN24131	Ø12	2	80 BAR	65.2	264
2	Seamless Precision Tube	AISI316	1 .4571,DIN24131	Ø12	2	250 BAR	24.1	102
3	Seamless Precision Tube	AISI316	1 .4571,DIN24131	Ø16	2	80 BAR	16.3	66
4	Seamless Precision Tube	AISI316	1 .4571,DIN24131	Ø16	2	30 BAR	9.6	42
5	Seamless Precision Tube	AISI316	1 .4571,DIN24131	Ø16	2	250 BAR	9.6	42
6	Seamless Precision Tube	AISI316	1 .4571,DIN24131	Ø20	2	30 BAR	9.6	42
7	Seamless Precision Tube	AISI316	1 .4571,DIN24131	Ø28	4	30 BAR	69	276
8	Seamless Precision Tube	AISI316	1 .4571,DIN24131	Ø28	4	80 BAR	16.3	66
9	Seamless Precision Tube	AISI316	1 .4571,DIN24131	Ø28	4	250 BAR	67.2	270
10	Seamless Precision Tube	AISI316	1 .4571,DIN24131	Ø42	6	250 BAR	40.4	162
11	Seamless Precision Tube	AISI316	1 .4571,DIN24131	Ø42	6	30 BAR	7.8	36
12	Seamless Precision Tube	AISI316	1 .4571,DIN24131	Ø42	3	30 BAR	7.8	36

## 2. Hydraulic Pipe Fittings

All hydraulic pipe fittings are to be of single ferrule type.

### a. Straight Connectors- Stainless steel

SI No.	Item Description	Material	Material Standard	Size OD (mm)	Working Pressure (bar)	QTY/ VESSEL (Nos)	QTY - 4 VESSEL (Nos)
1	Straight Connector	AISI316	DIN2353	Ø12	250 BAR	12	48
2	Straight Connector	AISI316	DIN2353	Ø12	80 BAR	33	132
3	Straight Connector	AISI316	DIN2353	Ø16	250 BAR	5	20
4	Straight Connector	AISI316	DIN2353	Ø16	30 BAR	5	20
5	Straight Connector	AISI316	DIN2353	Ø16	80 BAR	8	32
6	Straight Connector	AISI316	DIN2353	Ø20	s	5	20
7	Straight Connector	AISI316	DIN2353	Ø28	250 BAR	34	136
8	Straight Connector	AISI316	DIN2353	Ø28	30 BAR	34	136
9	Straight Connector	AISI316	DIN2353	Ø28	80 BAR	8	32
10	Straight Connector	AISI316	DIN2353	Ø42	250 BAR	21	84
11	Straight Connector	AISI316	DIN2353	Ø42	30 BAR	8	32

## 2. Hydraulic Pipe Fittings

All hydraulic pipe fittings are to be of single ferrule type.

### b. Elbow Connectors- Stainless steel

SI No.	Item Description	Material	Material Standard	Size OD (mm)	Working Pressure (bar)	QTY/ VESSEL (Nos)	QTY - 4 VESSEL (Nos)
1	Elbow Connector 90 deg	AISI316	DIN2353	Ø12	250 BAR	18	72
2	Elbow Connector 45 deg	AISI316	DIN2353	Ø12	250 BAR	4	16
3	Elbow Connector 90 deg	AISI316	DIN2353	Ø12	80 BAR	32	128
4	Elbow Connector 45 deg	AISI316	DIN2353	Ø12	80 BAR	8	32
5	Elbow Connector 90 deg	AISI316	DIN2353	Ø16	250 BAR	8	32
6	Elbow Connector 45 deg	AISI316	DIN2353	Ø16	250 BAR	2	8
7	Elbow Connector 90 deg	AISI316	DIN2353	Ø16	30 BAR	8	32
8	Elbow Connector 90 deg	AISI316	DIN2353	Ø16	80 BAR	12	48
9	Elbow Connector 45 deg	AISI316	DIN2353	Ø16	80 BAR	4	16
10	Elbow Connector 90 deg	AISI316	DIN2353	Ø20	30 BAR	8	32
11	Elbow Connector 90 deg	AISI316	DIN2353	Ø28	250 BAR	28	112
12	Elbow Connector 45 deg	AISI316	DIN2353	Ø28	250 BAR	10	40
13	Elbow Connector 90 deg	AISI316	DIN2353	Ø28	30 BAR	42	168
14	Elbow Connector 45 deg	AISI316	DIN2353	Ø28	30 BAR	12	48
15	Elbow Connector 90 deg	AISI316	DIN2353	Ø28	80 BAR	10	40
16	Elbow Connector 45 deg	AISI316	DIN2353	Ø28	80 BAR	2	8
17	Elbow Connector 90 deg	AISI316	DIN2353	Ø42	250 BAR	24	96
18	Elbow Connector 45 deg	AISI316	DIN2353	Ø42	250 BAR	8	32
19	Elbow Connector 90 deg	AISI316	DIN2353	Ø42	30 BAR	12	48
20	Elbow Connector 45 deg	AISI316	DIN2353	Ø42	30 BAR	2	8

## 2. Hydraulic Pipe Fittings

All hydraulic pipe fittings are to be of single ferrule type.

### c. Tee Connectors- Stainless steel

SI No.	Item Description	Material	Material Standard	Size OD (mm)	Working Pressure (bar)	QTY/ VESSEL (Nos)	QTY - 4 VESSEL (Nos)
1	Equal Tee Connector	AISI316	DIN2353	Ø28	30 BAR	3	12
2	Equal Tee Connector	AISI316	DIN2353	Ø42	30 BAR	1	4
3	Equal Tee Connector	AISI316	DIN2353	Ø42	250 BAR	1	4

## 2. Hydraulic Pipe Fittings

All hydraulic pipe fittings are to be of single ferrule type.

### d. Reducer Connectors- Stainless steel

SI No.	Item Description	Material	Material Standard	Size OD (mm)	Working Pressure (bar)	QTY/ VESSEL (Nos)	QTY - 4 VESSEL (Nos)
1	Straight Reducing Connector	AISI316	DIN2353	Ø12x10	250 BAR	2	8
2	Straight Reducing Connector	AISI316	DIN2353	Ø12x10	80 BAR	4	16
3	Straight Reducing Connector	AISI316	DIN2353	Ø16x15	30 BAR	2	8
4	Straight Reducing Connector	AISI316	DIN2353	Ø16x15	80 BAR	2	8
5	Straight Reducing Connector	AISI316	DIN2353	Ø28x16	30 BAR	1	4
6	Straight Reducing Connector	AISI316	DIN2353	Ø28x25	250 BAR	4	16
7	Straight Reducing Connector	AISI316	DIN2353	Ø42x28	250 BAR	1	4
8	Straight Reducing Connector	AISI316	DIN2353	Ø42x28	30 BAR	1	4
9	Straight Reducing Connector	AISI316	DIN2353	Ø42x38	250 BAR	5	20

## 2. Hydraulic Pipe Fittings


All hydraulic pipe fittings are to be of single ferrule type.

### e. Bulkhead Penetration fitting- Both sides ferruled

SI No.	Item Description	Material	Material Standard	Size OD (mm)	Working Pressure (bar)	QTY/ VESSEL (Nos)	QTY - 4 VESSEL (Nos)
1	Weld Bulkhead Fitting	AISI316	DIN2353	Ø12	250 BAR	4	16
2	Weld Bulkhead Fitting	AISI316	DIN2353	Ø12	80 BAR	8	32
3	Weld Bulkhead Fitting	AISI316	DIN2353	Ø16	250 BAR	2	8
4	Weld Bulkhead Fitting	AISI316	DIN2353	Ø16	30 BAR	2	8
5	Weld Bulkhead Fitting	AISI316	DIN2353	Ø16	80 BAR	2	8
6	Weld Bulkhead Fitting	AISI316	DIN2353	Ø20	30 BAR	2	8
7	Weld Bulkhead Fitting	AISI316	DIN2353	Ø28	250 BAR	8	32
8	Weld Bulkhead Fitting	AISI316	DIN2353	Ø28	30 BAR	10	40
9	Weld Bulkhead Fitting	AISI316	DIN2353	Ø28	80 BAR	2	8
10	Weld Bulkhead Fitting	AISI316	DIN2353	Ø42	250 BAR	4	16

## 3. Hydraulic Pipe Supports

SI No.	Item Description	Size OD (mm)	Working Pressure (bar)	QTY/ VESSEL (Nos.)	QTY - 4 VESSEL (Nos.)
1	Box Type Hyd. Support- Heavy Duty	Ø12	250 BAR	15	60
2	Box Type Hyd. Support- Heavy Duty	Ø12	80 BAR	40	160
3	Box Type Hyd. Support- Heavy Duty	Ø16	250 BAR	10	40
4	Box Type Hyd. Support- Heavy Duty	Ø16	30 BAR	10	40
5	Box Type Hyd. Support- Heavy Duty	Ø16	80 BAR	10	40
6	Box Type Hyd. Support- Heavy Duty	Ø20	30 BAR	8	32
7	Box Type Hyd. Support- Heavy Duty	Ø28	250 BAR	35	140
8	Box Type Hyd. Support- Heavy Duty	Ø28	30 BAR	35	140
9	Box Type Hyd. Support- Heavy Duty	Ø28	80 BAR	10	40
10	Box Type Hyd. Support- Heavy Duty	Ø42	250 BAR	25	100
11	Box Type Hyd. Support- Heavy Duty	Ø42	30 BAR	8	32

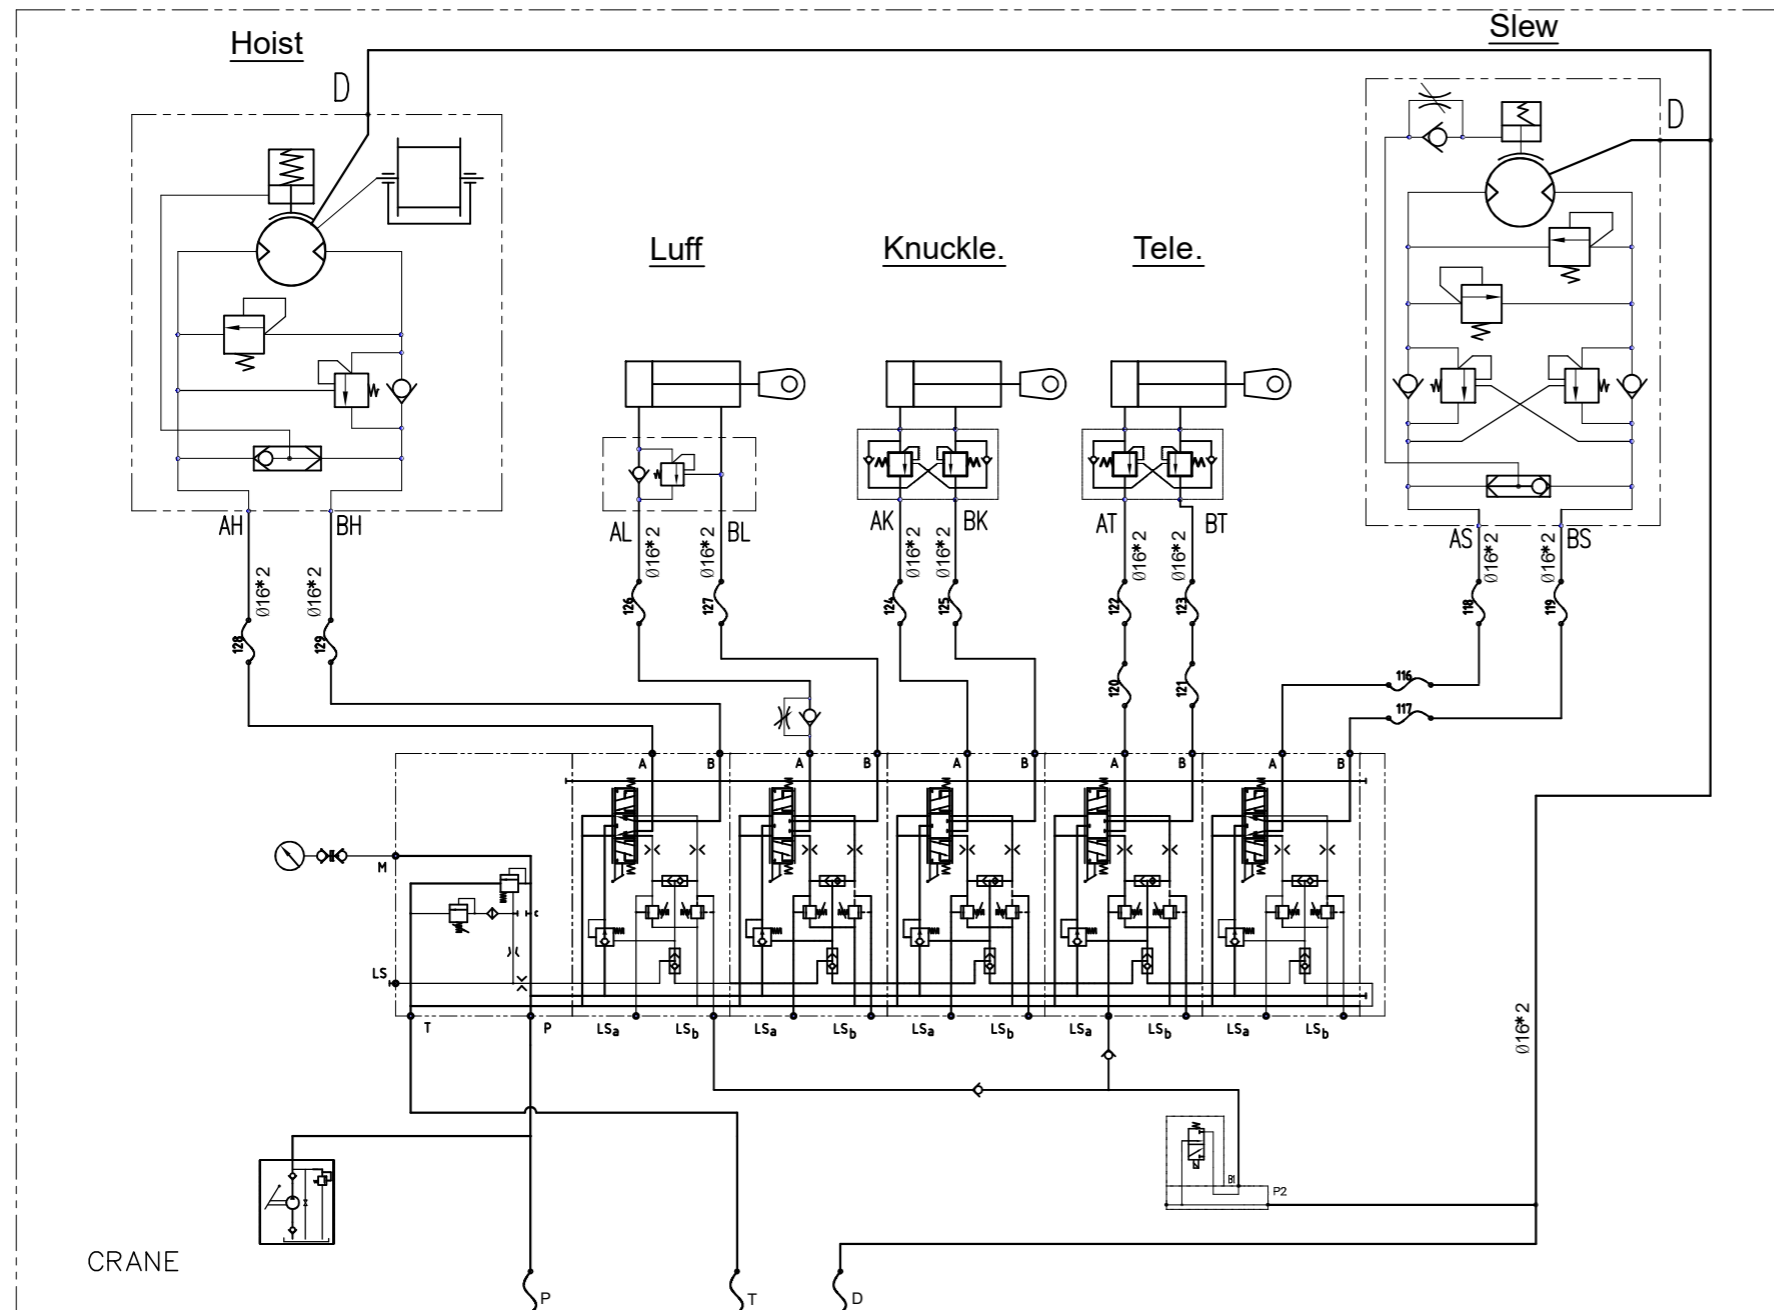


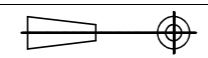
PORT CONNECTION :  
The following are all Welding form


KTC:	
P	16*2.0 WELDING CONE
T	20*2.0 WELDING CONE
D	16*2.0 WELDING CONE

HPU:	
P	16*2.0 WELDING CONE
T	20*2.0 WELDING CONE
D	16*2.0 WELDING CONE

DECK

COMMERCIAL IN CONFIDENCE:  
This document contains confidential information. All rights (including copyright, confidential information, trade secrets and design rights) are owned by W-RIG. No use or disclosure is to be made without prior written permission of W-RIG.

Rev	A1	TITLE :	HYDRAULIC SCHEMATIC / PIPING LAYOUT	
W-rig No.	Date	2024.12.15		
W0497R1/498R1 W0506R1/507R1	Approved	WG		
Hull No.	Checked	ZJY		SCALE: 1:1
01124001/01224002 01324003/01424004	Drawn	GK/WXD	WT.:	SHT. 1/1
				MODEL NO.:--
				DRG. NO.: HSP-HKTC-GA

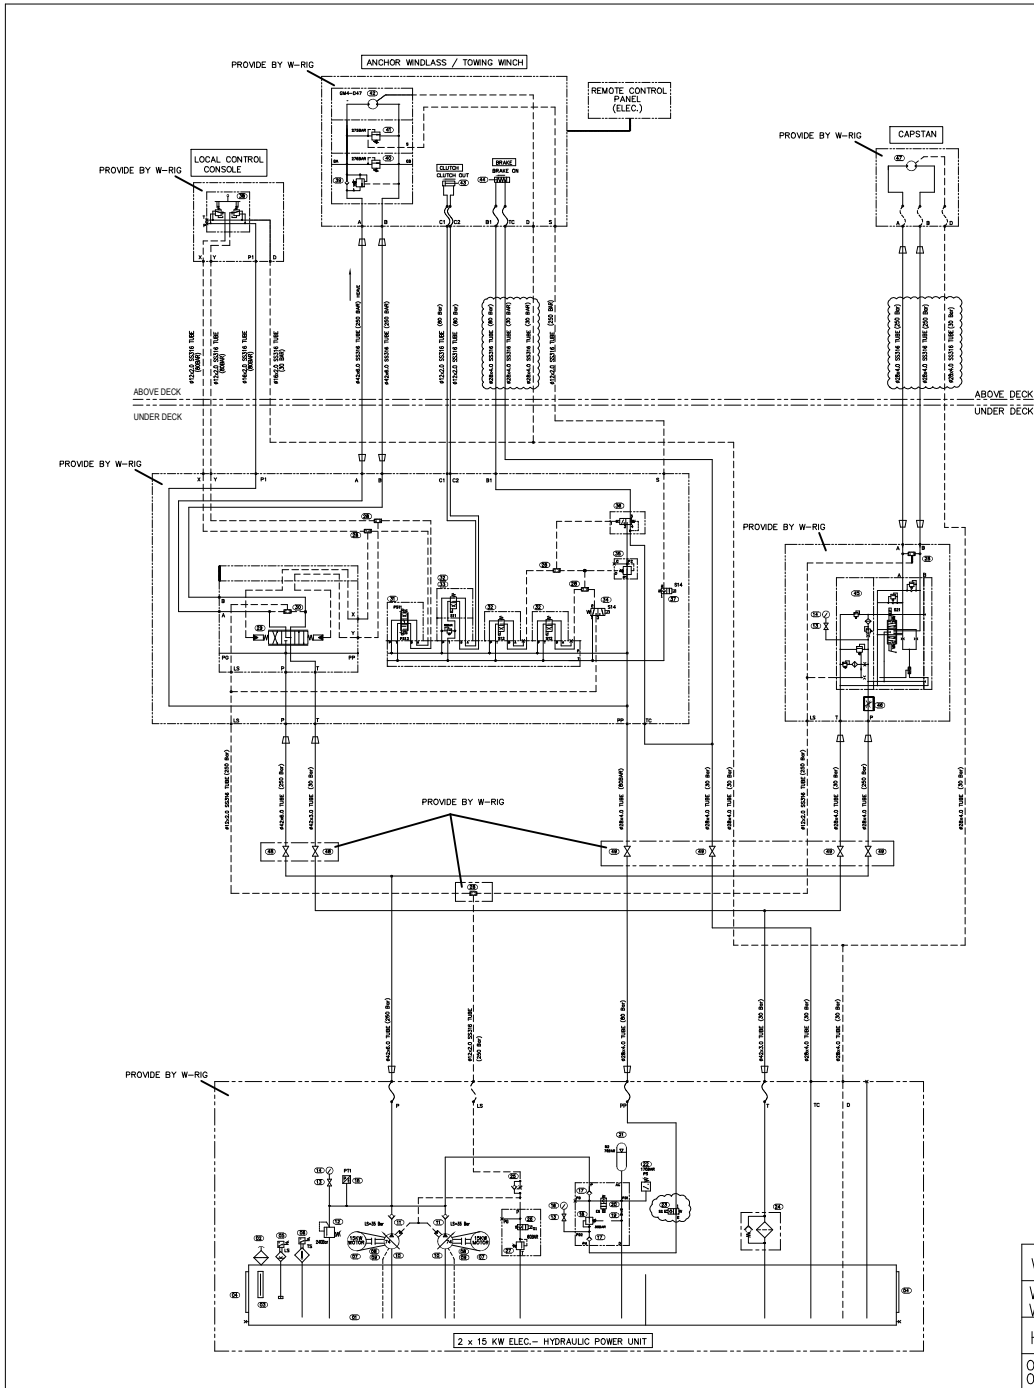

NOTE:

1. ALL TUBE TO BE SEAMLESS PRECISION STAINLESS STEEL TUBE AND THE SPECIFICATION TO BE COMPLY TO 1.4571, DIN24131.
2. ALL WELDING PIPE TO BE SEAMLESS STEEL PIPE AND THE MATERIAL TO BE ANSI 316 or C20, GB5312-85.
3. ALL HOSES PERFORMANCE TO BE MEET OR EXCEED SAE100R1AT, SAER2AT, SAE100 R12/13, IF ANY.
4. SUFFICIENT FLUSHING TO REMOVE FOREIGN MATTERS IN PIPES ARE NECESSARY AFTER PIPING INSTALLATION. THE OIL CLEANLINESS TO BE MEET OF ISO 18/16/14 OR BETTER.
5. PIPELINES ON COMPLETION TO BE HYDRAULICALLY TESTED TO 1.5 TIMES WORKING PRESSURE.

REMARK:

1. ALL TUBES, PIPES, FITTINGS BEYOND HYDRAULIC POWER UNITS, CONTROL UNIT AND WINCHES WILL BE SUPPLIED BY YARD.

REMARK:

➔ NORMALLY CLOSED

PORT CONNECTION :

The following are all Welding form

AWT:	
A/B	38*5.0 WELDING CONE
C1/C2	#14 WELDABLE STUD CONE LENGTH OF HOSES? 800mm
B1	28*2.5 WELDING CONE LENGTH OF HOSES? 1100mm
TC	28*2.5 WELDING CONE LENGTH OF HOSES? 500mm
D	28*2.5 WELDING CONE
LCC-TGW:	
P1/D	18*2.0 WELDING CONE
X/Y	10*2.0 WELDING CONE
HCU-TGW:	
P	38*5.0 WELDING CONE
T	42*3.0 WELDING CONE
A/B	38*5.0 WELDING CONE
P1	16*2.0 WELDING CONE
X/Y	10*2.0 WELDING CONE
C1/C2	10*2.0 WELDING CONE
B1	28*2.5 WELDING CONE
PP	28*2.5 WELDING CONE
TC	28*2.5 WELDING CONE
LS	10*2.0 WELDING CONE

CPT:	
A/B	25*3.0 WELDING CONE LENGTH OF HOSES? 800mm
D	28*2.5 WELDING CONE LENGTH OF HOSES? 800mm
LCC-CPT:	
A/B	25*3.0 WELDING CONE
P	25*3.0 WELDING CONE
T	28*2.5 WELDING CONE
LS	10*2.0 WELDING CONE
HPU:	
P	#44 WELDABLE STUD CONE LENGTH OF HOSES? 800mm
T	42*3.0 WELDING CONE LENGTH OF HOSES? 800mm
PP	28*2.5 WELDING CONE LENGTH OF HOSES? 800mm
LS	10*2.0 WELDING CONE LENGTH OF HOSES? 800mm
TC	28*2.5 WELDING CONE
D	28*2.5 WELDING CONE

NO	DESCRIPTION	QTY	PART LIST
1	RESERVOIR	1	HCS-W0497-AWT-01
2	AIR BREATHER	1	HCS-W0497-AWT-02
3	OIL LEVEL GAUGE	1	HCS-W0497-AWT-03
4	INSPECTION COVER	2	HCS-W0497-AWT-04
5	OIL LEVEL SWITCH	1	HCS-W0497-AWT-05
6	THERMOSTAT	1	HCS-W0497-AWT-06
7	ELECTRIC MOTOR (15KW)	2	HCS-W0497-AWT-07
8	BELL HOUSING	2	HCS-W0497-AWT-08
9	DRIVE COUPLING	2	HCS-W0497-AWT-09
10	HYDRAULIC PISTON PUMP	2	HCS-W0497-AWT-10
11	CHECK VALVE	2	HCS-W0497-AWT-11
12	PRESSURE RELIEF VALVE	1	HCS-W0497-AWT-12
13	NEEDLE VALVE	3	HCS-W0497-AWT-13
14	PRESSURE GAUGE	2	HCS-W0497-AWT-14
15	PRESSURE TRANSDUCER	1	HCS-W0497-AWT-15
16	PRESSURE GAUGE	1	HCS-W0497-AWT-16
17	CHECK VALVE	2	HCS-W0497-AWT-17
18	PRESSURE REDUCING VALVE	1	HCS-W0497-AWT-18
19	NEEDLE VALVE	1	HCS-W0497-AWT-19
20	SOLENOID VALVE	1	HCS-W0497-AWT-20
21	ACCUMULATOR (20L)	1	HCS-W0497-AWT-21
22	PRESSURE SWITCH	1	HCS-W0497-AWT-22
23	SOLENOID VALVE	1	HCS-W0497-AWT-23
24	RETURN FILTER	1	HCS-W0497-AWT-24
25	FLOW CONTROL VALVE	1	HCS-W0497-AWT-25
26	SOLENOID VALVE	1	HCS-W0497-AWT-26
27	PRESSURE RELIEF VALVE	2	HCS-W0497-AWT-27
28	SHUTTLE VALVE	6	HCS-W0497-AWT-28
29	PROPORTIONAL DCV	1	HCS-W0497-AWT-29
30	SHUTTLE VALVE	1	HCS-W0497-AWT-30
31	PROPORTIONAL DCV	1	HCS-W0497-AWT-31
32	SOLENOID VALVE	3	HCS-W0497-AWT-32
33	PRESSURE RELIEF VALVE	1	HCS-W0497-AWT-33
34	SOLENOID VALVE	1	HCS-W0497-AWT-34
35	PRESSURE REDUCING VALVE	1	HCS-W0497-AWT-35
36	PILOT OPERATED VALVE	1	HCS-W0497-AWT-36
37	SOLENOID VALVE	1	HCS-W0497-AWT-37
38	HYDRAULIC JOYSTICK	1	HCS-W0497-AWT-38
39	COUNTERBALANCE VALVE	1	HCS-W0497-AWT-39
40	PRESSURE RELIEF VALVE	1	HCS-W0497-AWT-40
41	PRESSURE RELIEF VALVE	1	HCS-W0497-AWT-41
42	HYDRAULIC MOTOR	1	HCS-W0497-AWT-42
43	CLUTCH CYLINDER	1	HCS-W0497-AWT-43
44	BRAKE CYLINDER	1	HCS-W0497-AWT-44
45	FLOW CONTROL VALVE	1	HCS-W0497-AWT-45
46	MANUAL OPERATED DCV	1	HCS-W0497-AWT-46
47	HYDRAULIC MOTOR	1	HCS-W0497-AWT-47
48	BALL VALVE, 1.25" PN=250BAR	2	HCS-W0497-AWT-48
49	BALL VALVE, 3/4" PN=250BAR	4	HCS-W0497-AWT-49

Rev	F	TITLE :	HYDRAULIC SCHEMATIC / PIPING LAYOUT
W-rig No.	Date 2024.12.18		
W0497/98 W0506/07	Approved WG		
Hull No.	Checked ZJY	CSALE: 4:1	MODEL NO.: -
01124001/01224002 01324003/01424004	Drawn WXD	WT. : ~KG	DRG. NO.: W0497~98-HCS-AWT






注記 NOTE

1. 船装回油圧配管ハ、造船所殿ニテ酸洗イテ実施願イマス。  
THE ACID PICKLING SHOULD BE OPERATED BY SHIPYARD FOR THE HYDRAULIC SHIPYARD PIPING.
2. 船装回油圧配管ハ、造船所殿ニテフラッシングイテ実施願イマス。  
THE FLASHING SHOULD BE OPERATED BY SHIPYARD FOR THE HYDRAULIC SHIPYARD PIPING.
3. ※印ノ船装油配管ハ、バルブヲ装着セズニ配管願イマス。  
THE HYDRAULIC SHIPYARD PIPING MARKED '※' SHOULD BE SET ONTO THE STEERING SYSTEM WITHOUT CONNECTING VALVES.

FOR STBD

造船所殿所掌配管  
SHIPYARD PIPING

冷却水配管 COOLING WATER PIPING	(MAX 0.15MPa)
作動油低圧配管 HYDRAULIC PIPING (LOW PRESS.)	(MAX 0.5MPa)
作動油高圧配管 HYDRAULIC PIPING (HIGH PRESS.)	(MAX 26MPa)

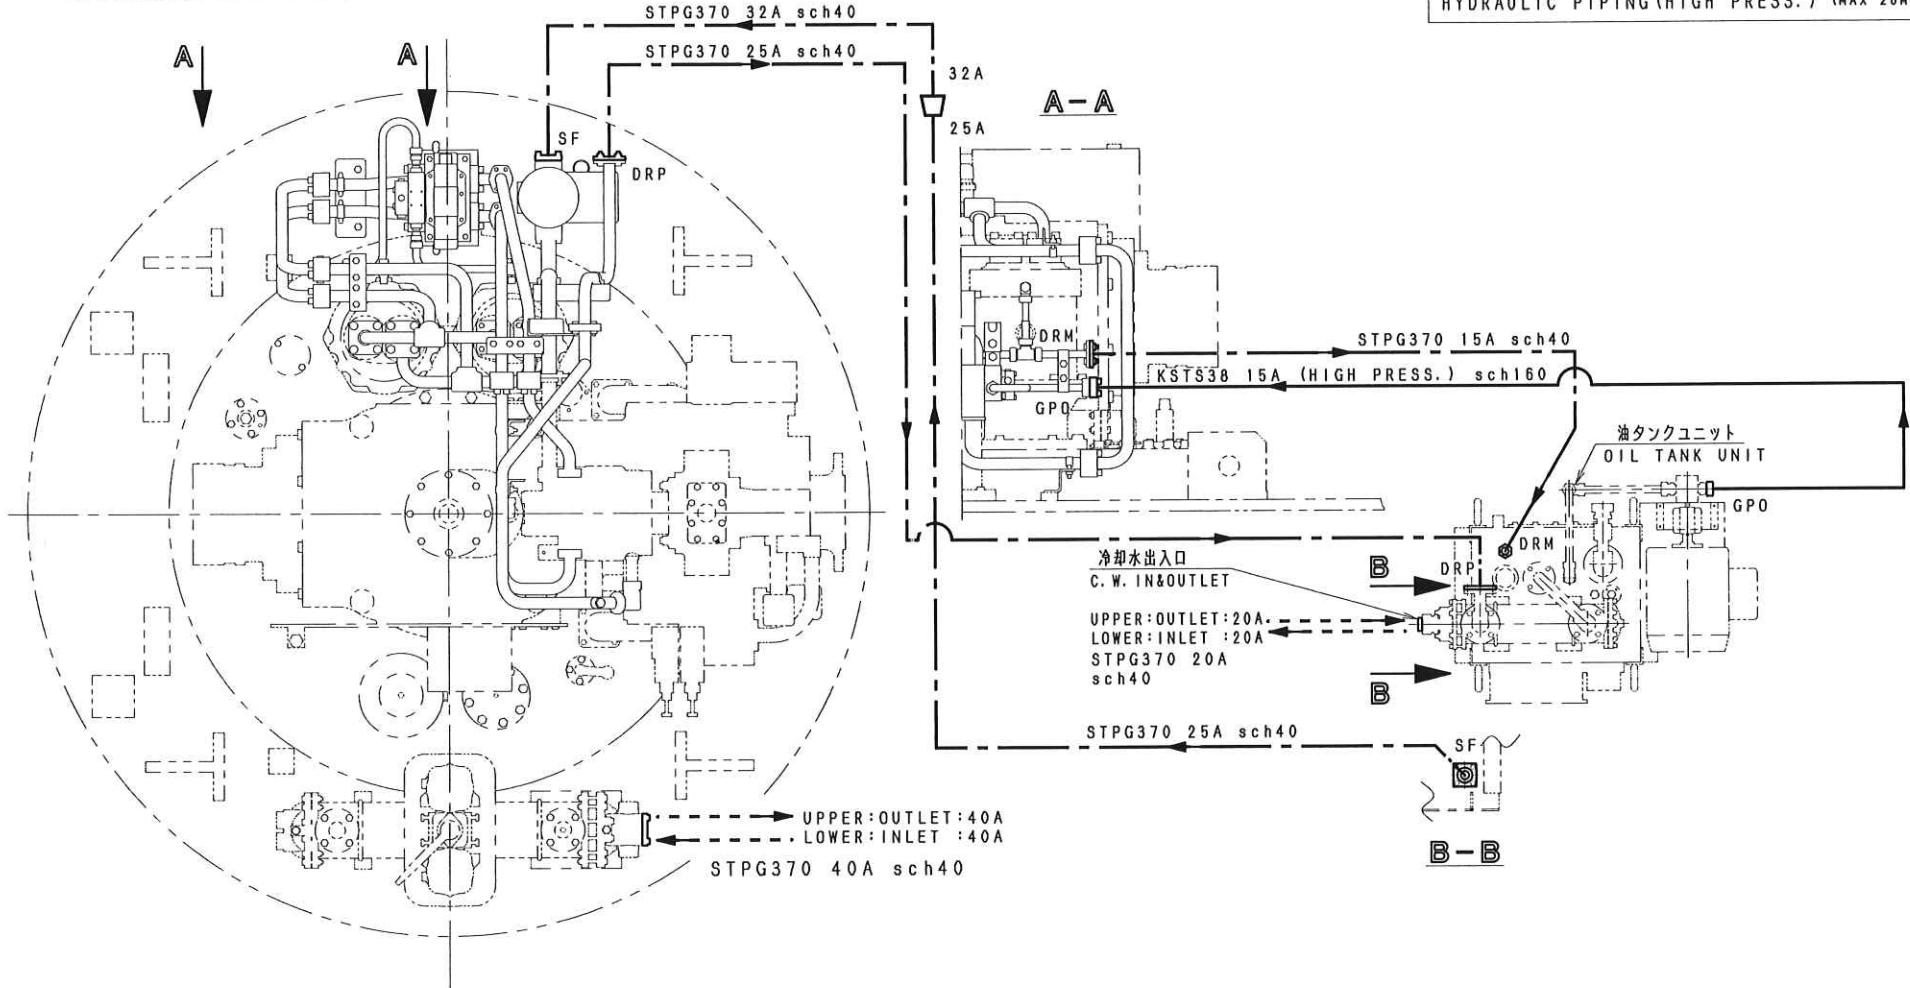


承認 APPD.	概要 DESCRIPTION CL格取 溶接台床 旋回補助P有 右舷	承認 APPD.	図名 TITLE センカイユアツハイカン HYDRAULIC PIPING
照査 REV.	参照図 REF. DRW.	照査 REV.	
変更 CHG.	参照図書 REF. NO.	担当 CHD.	図番 DRAWING NO. AM7300-002900
改訂 REV.	変更前号 BEFORE NO.	製図 DWN.	改訂 REV. 1
記号 来歴	発行先 ISSUED FOR ZP-21	尺貫 SCALE 1:15	年月日 DATE 2025/01/30
	年月日	株式会社 IHI 原動機 IHI Power Systems Co., Ltd.	

注記 NOTE

1. 船装戻油圧配管ハ、造船所殿ニテ酸洗イテ実施願イマス。  
THE ACID PICKLING SHOULD BE OPERATED BY SHIPYARD FOR THE HYDRAULIC SHIPYARD PIPING.
2. 船装戻油圧配管ハ、造船所殿ニテフラッシングヲ実施願イマス。  
THE FLASHING SHOULD BE OPERATED BY SHIPYARD FOR THE HYDRAULIC SHIPYARD PIPING.
3. ※印ノ船装油配管ハ、バルブヲ装着セズニ配管願イマス。  
THE HYDRAULIC SHIPYARD PIPING MARKED '※' SHOULD BE SET ONTO THE STEERING SYSTEM WITHOUT CONNECTING VALVES.

FOR PORT  
造船所殿所掌配管  
SHIPYARD PIPING

冷却水配管  
COOLING WATER PIPING (MAX 0.15MPa)  
作動油低圧配管  
HYDRAULIC PIPING (LOW PRESS.) (MAX 0.5MPa)  
作動油高圧配管  
HYDRAULIC PIPING (HIGH PRESS.) (MAX 26MPa)

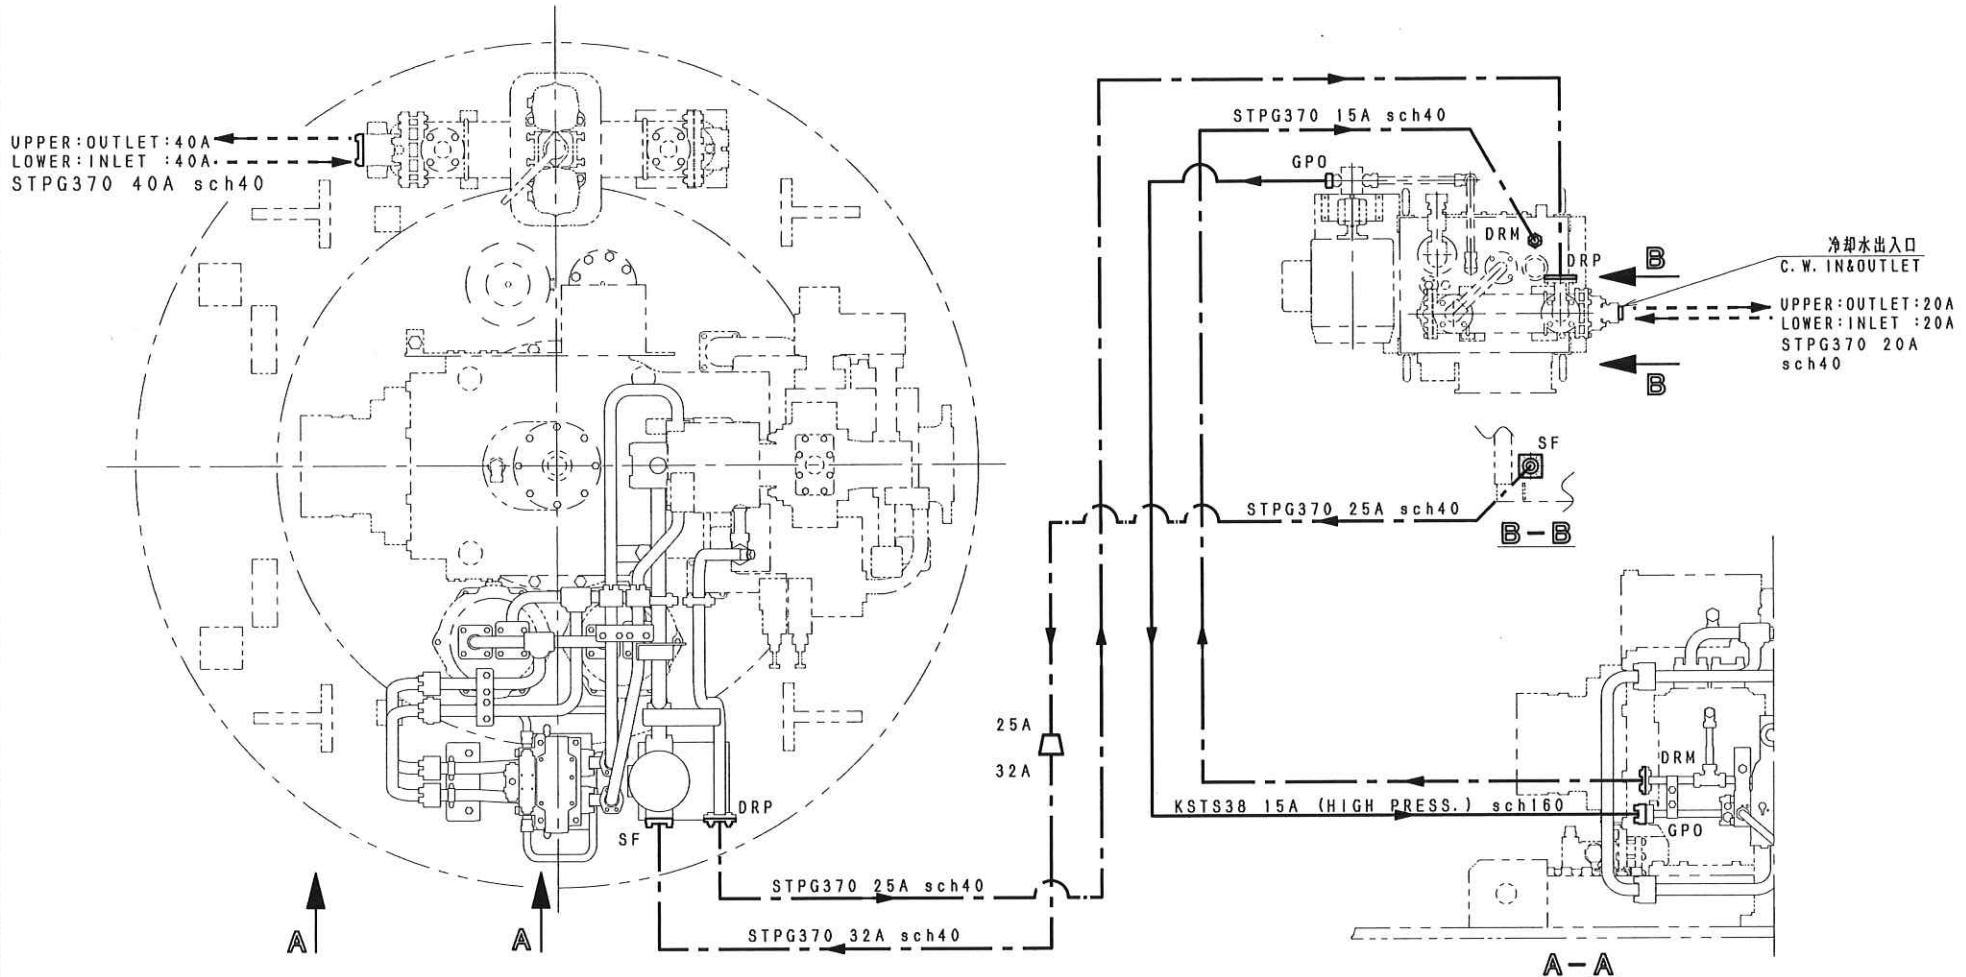

△ △ △ △	承認 APPD.	概要 DESCRIPTION	承認 APPD.	図名 TITLE
	照査 REV.	C.L拾取、油接台床、旋回補助P有、左舷	齊藤	センカイユアツハイカン
	変更 CHG.	参照図 REF. DRW.	齊藤	HYDRAULIC PIPING
	変更前 BEFORE NO.	参照図 REF. NO.	三ツ田	
△ K245863_印CS造451殿向トシテ調製 記号 来歴	使用先 ISSUED FOR ZP-21 年月日	変更前 BEFORE NO. 尺規 SCALE 1:15 株式会社IHI原動機 IHI Power Systems Co., Ltd.	製図 DWN. 三ツ田 年月日 DATE 2025/01/30	図番 DRAWING NO. AM7300-00301001/1 改訂 REV. 1